



# SCHOOL INFRASTRUCTURE NSW



# HUNTER RIVER HIGH SCHOOL


36 ELKIN AVENUE,  
HEATHERBRAE NSW  
2324

REVISED SCHEMATIC DESIGN ISSUE  
01/09/2023

Stantec Project Number: 301350909

DRAWING LIST	
NO.	DRAWING NAME
HRHS-STNC-XX-XX-DR-C-000001	COVER SHEET, DRAWING REGISTRY AND LOCALITY PLAN
HRHS-STNC-XX-XX-DR-C-007001	GENERAL NOTES
HRHS-STNC-XX-XX-DR-C-050001	EXISTING CONDITIONS PLAN
HRHS-STNC-XX-XX-DR-C-055001	DEMOLITION PLAN
HRHS-STNC-XX-XX-DR-C-060001	GENERAL ARRANGEMENT PLAN SITE WIDE
HRHS-STNC-XX-XX-DR-C-060101	SITEWORKS PLAN-SHEET 1
HRHS-STNC-XX-XX-DR-C-060102	SITEWORKS PLAN-SHEET 2
HRHS-STNC-XX-XX-DR-C-060103	SITEWORKS PLAN-SHEET 3
HRHS-STNC-XX-XX-DR-C-060104	SITEWORKS PLAN-SHEET 4
HRHS-STNC-XX-XX-DR-C-060105	SITEWORKS PLAN-SHEET 5
HRHS-STNC-XX-XX-DR-C-060106	SITEWORKS PLAN-SHEET 6
HRHS-STNC-XX-XX-DR-C-060107	SITEWORKS PLAN-SHEET 7
HRHS-STNC-XX-XX-DR-C-060108	SITEWORKS PLAN-SHEET 8
HRHS-STNC-XX-XX-DR-C-060109	SITEWORKS PLAN-SHEET 9
HRHS-STNC-XX-XX-DR-C-070001	EROSION AND SEDIMENT CONTROL PLAN
HRHS-STNC-XX-XX-DR-C-076001	EROSION AND SEDIMENT CONTROL DETAILS
HRHS-STNC-XX-XX-DR-C-100001	BULK EARTHWORKS PLAN
HRHS-STNC-XX-XX-DR-C-403001	ROADS TYPICAL SECTIONS SHEET 1
HRHS-STNC-XX-XX-DR-C-406001	ROADS DETAILS SHEET 1
HRHS-STNC-XX-XX-DR-C-406002	ROADS DETAILS SHEET 2
HRHS-STNC-XX-XX-DR-C-406003	ROADS DETAILS SHEET 3
HRHS-STNC-XX-XX-DR-C-440101	PAVEMENT PLAN SHEET 1
HRHS-STNC-XX-XX-DR-C-440102	PAVEMENT PLAN SHEET 2
HRHS-STNC-XX-XX-DR-C-440103	PAVEMENT PLAN SHEET 3
HRHS-STNC-XX-XX-DR-C-440104	PAVEMENT PLAN SHEET 4
HRHS-STNC-XX-XX-DR-C-440105	PAVEMENT PLAN SHEET 5
HRHS-STNC-XX-XX-DR-C-440106	PAVEMENT PLAN SHEET 6
HRHS-STNC-XX-XX-DR-C-440107	PAVEMENT PLAN SHEET 7
HRHS-STNC-XX-XX-DR-C-440108	PAVEMENT PLAN SHEET 8

HRHS-STNC-XX-XX-DR-C-440109	PAVEMENT PLAN SHEET 9
HRHS-STNC-XX-XX-DR-C-520001	STORMWATER DRAINAGE PLAN SITE WIDE
HRHS-STNC-XX-XX-DR-C-526001	STORMWATER DRAINAGE DETAILS SHEET 1
HRHS-STNC-XX-XX-DR-C-526002	STORMWATER DRAINAGE DETAILS SHEET 2
HRHS-STNC-XX-XX-DR-C-526003	STORMWATER DRAINAGE DETAILS SHEET 3
HRHS-STNC-XX-XX-DR-C-526004	STORMWATER DRAINAGE DETAILS SHEET 4
HRHS-STNC-XX-XX-DR-C-527001	STORMWATER DRAINAGE PIT SCHEDULE

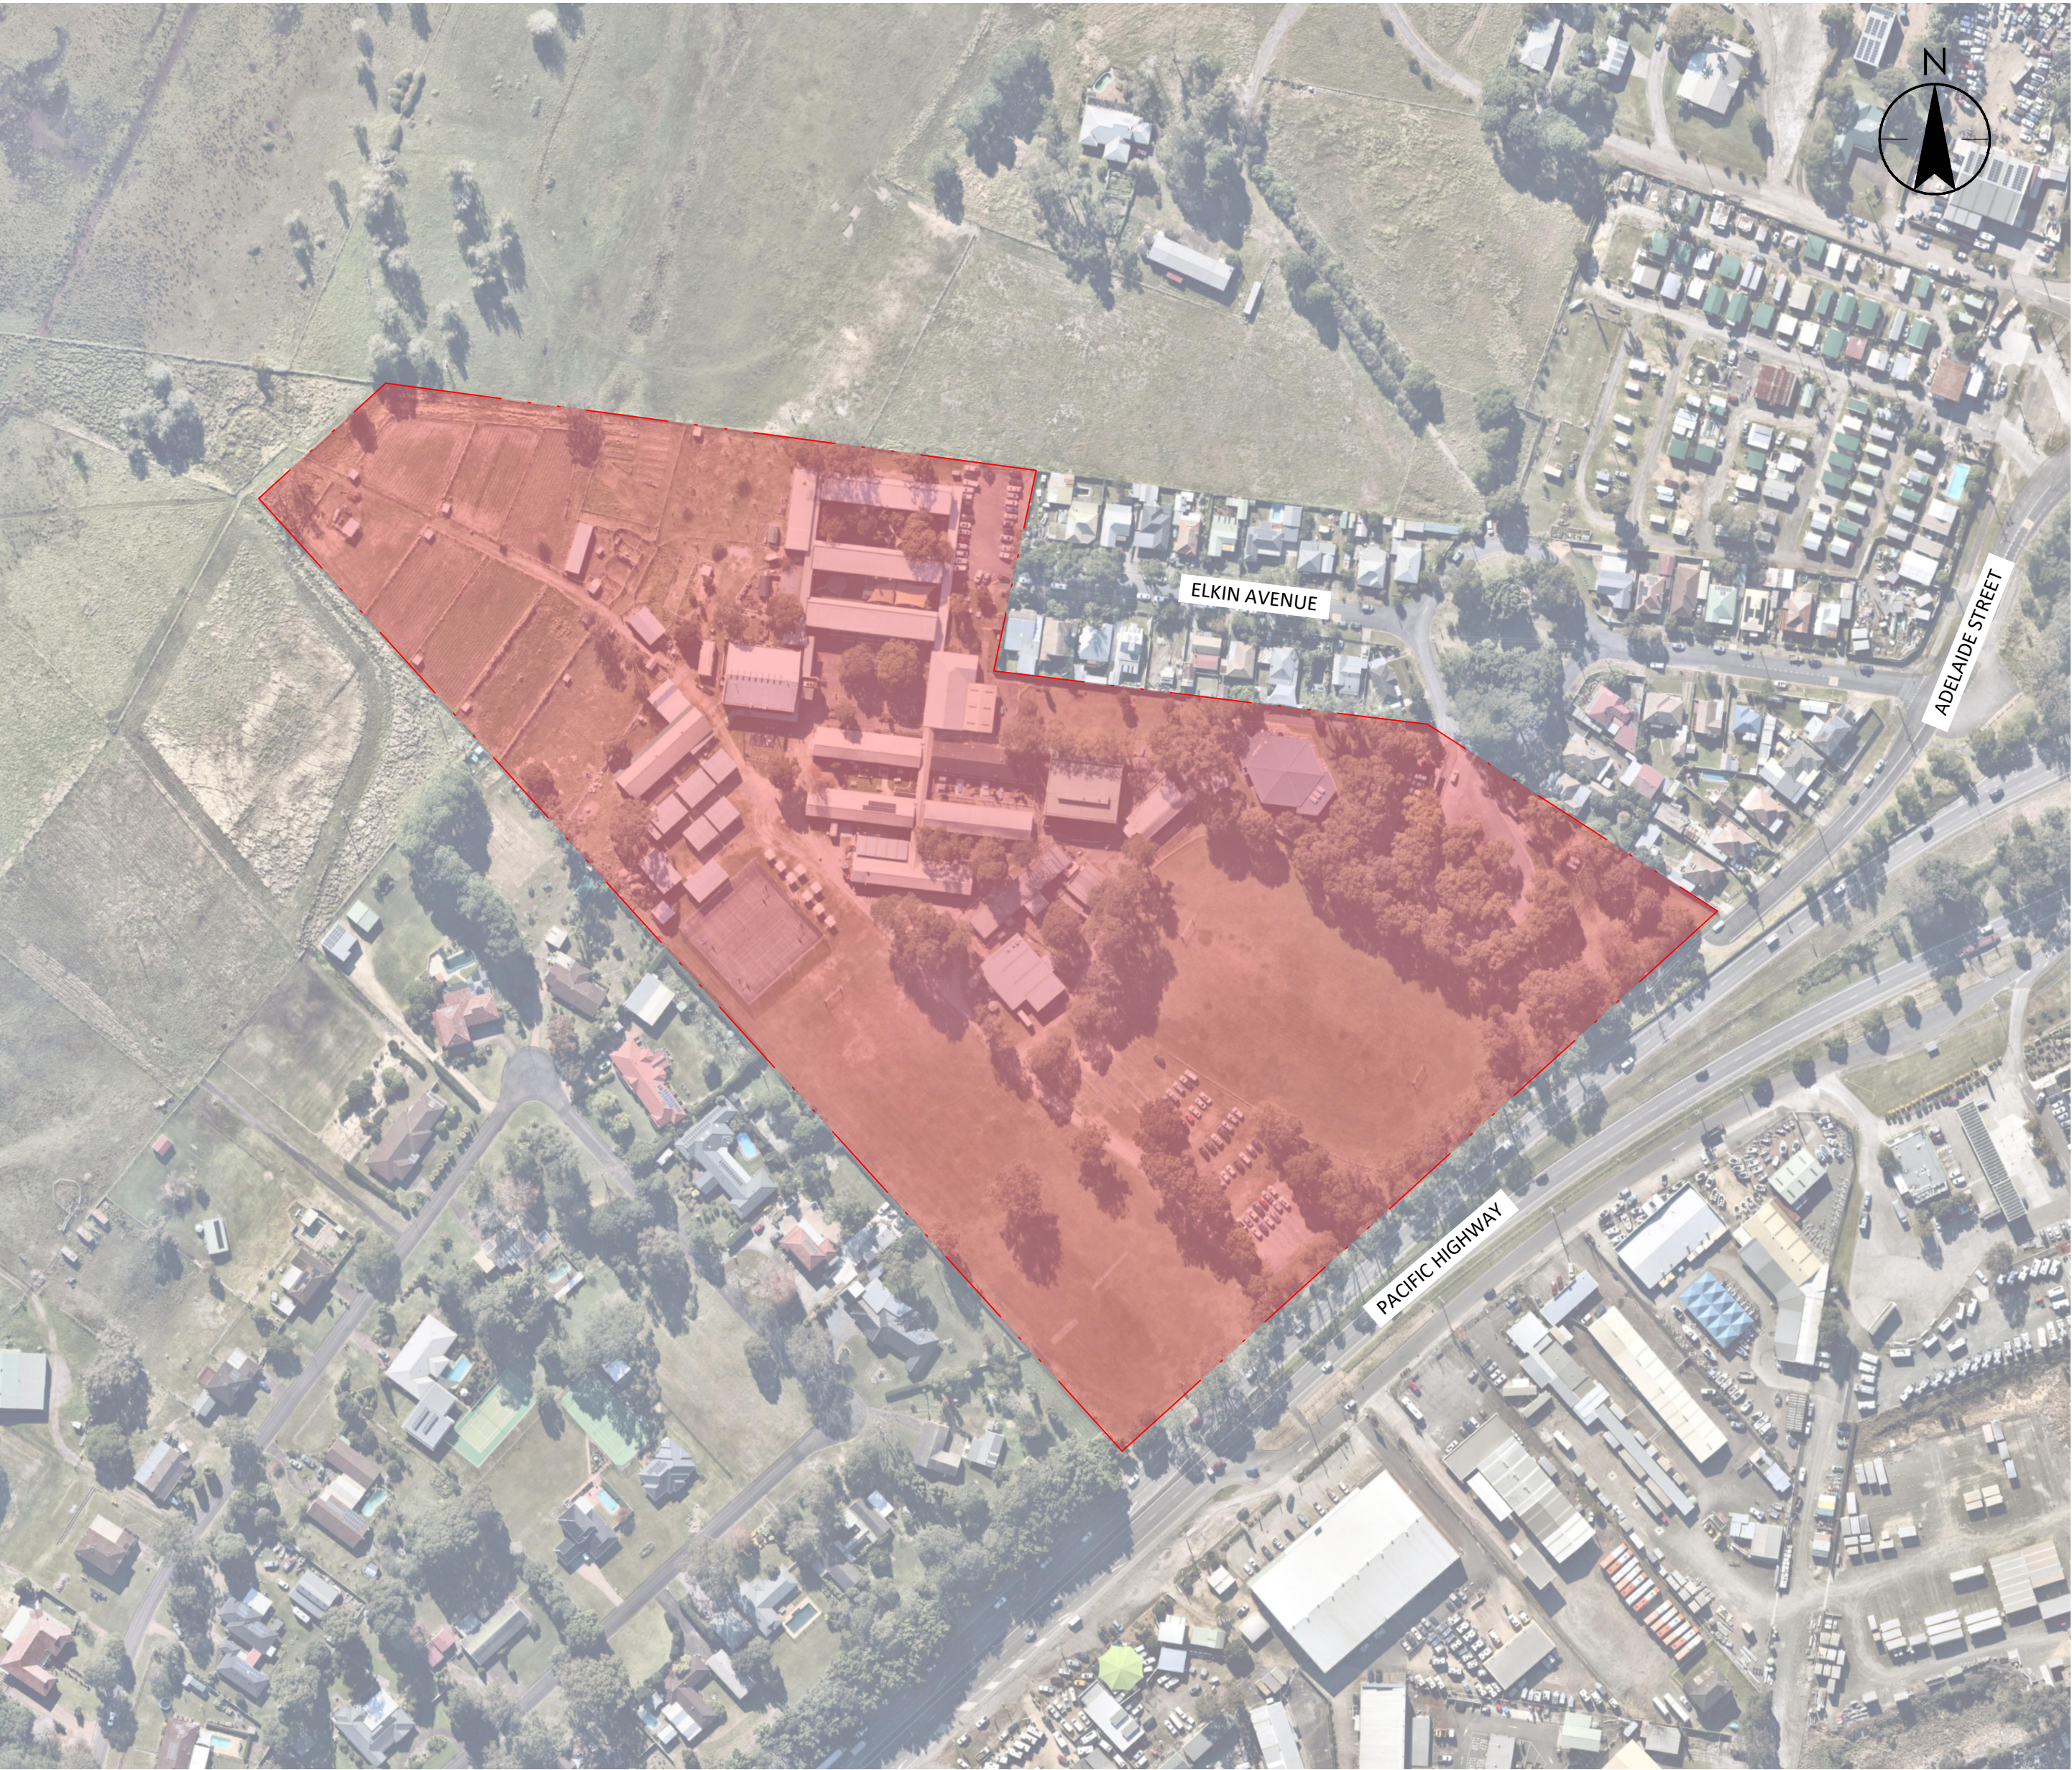









Notes

F	REVISED SCHEMATIC DESIGN	BCH	JMB	2023.09.01
E	REVISED SCHEMATIC DESIGN	CPO	JMB	2023.04.13
D	DRAFT REVISED SCHEMATIC DESIGN ISSUE	CPO	JMB	2023.03.24
C	FINAL PHASE 3 ISSUE	CPO	JMB	2022.08.08
B	100% SCHEMATIC DESIGN PROCESS	CPO	JMB	2022.07.29
A	95% SCHEMATIC DESIGN PROCESS	CPO	JMB	2022.07.14
Issued/Revision		By	Appd	YYYY.MM.DD

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HUNTERS RIVER HIGH SCHOOL

HEATHERBRAE NSW 2324

File Name: HRHS-STNC-XX-XX-DR-C-050001.DWG

CPO	JMB	JMB	2022.07.14
Dwn.	Dign.	Chkd.	YYYY.MM.DD

Title




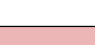
EXISTING CONDITIONS PLAN


Project No. \_\_\_\_\_ Scale \_\_\_\_\_

Revision **F** Drawing No. **HRHS-STNC-XX-XX-DR-C-050001**





LEGEND	
	SITE BOUNDARY
	EXISTING BUILDINGS
	AREAS TO BE DEMOLISHED
	TREES TO BE REMOVED

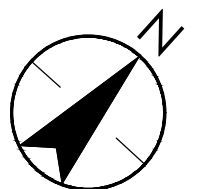

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## Notes

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HEATHERBRAE NSW 2324

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Title

DEMOLITION PLAN


Project No.

Scale  
1:750

Revision  
F

Drawing No.  
**HRHS-STNC-XX-XX-DR-C-055001**



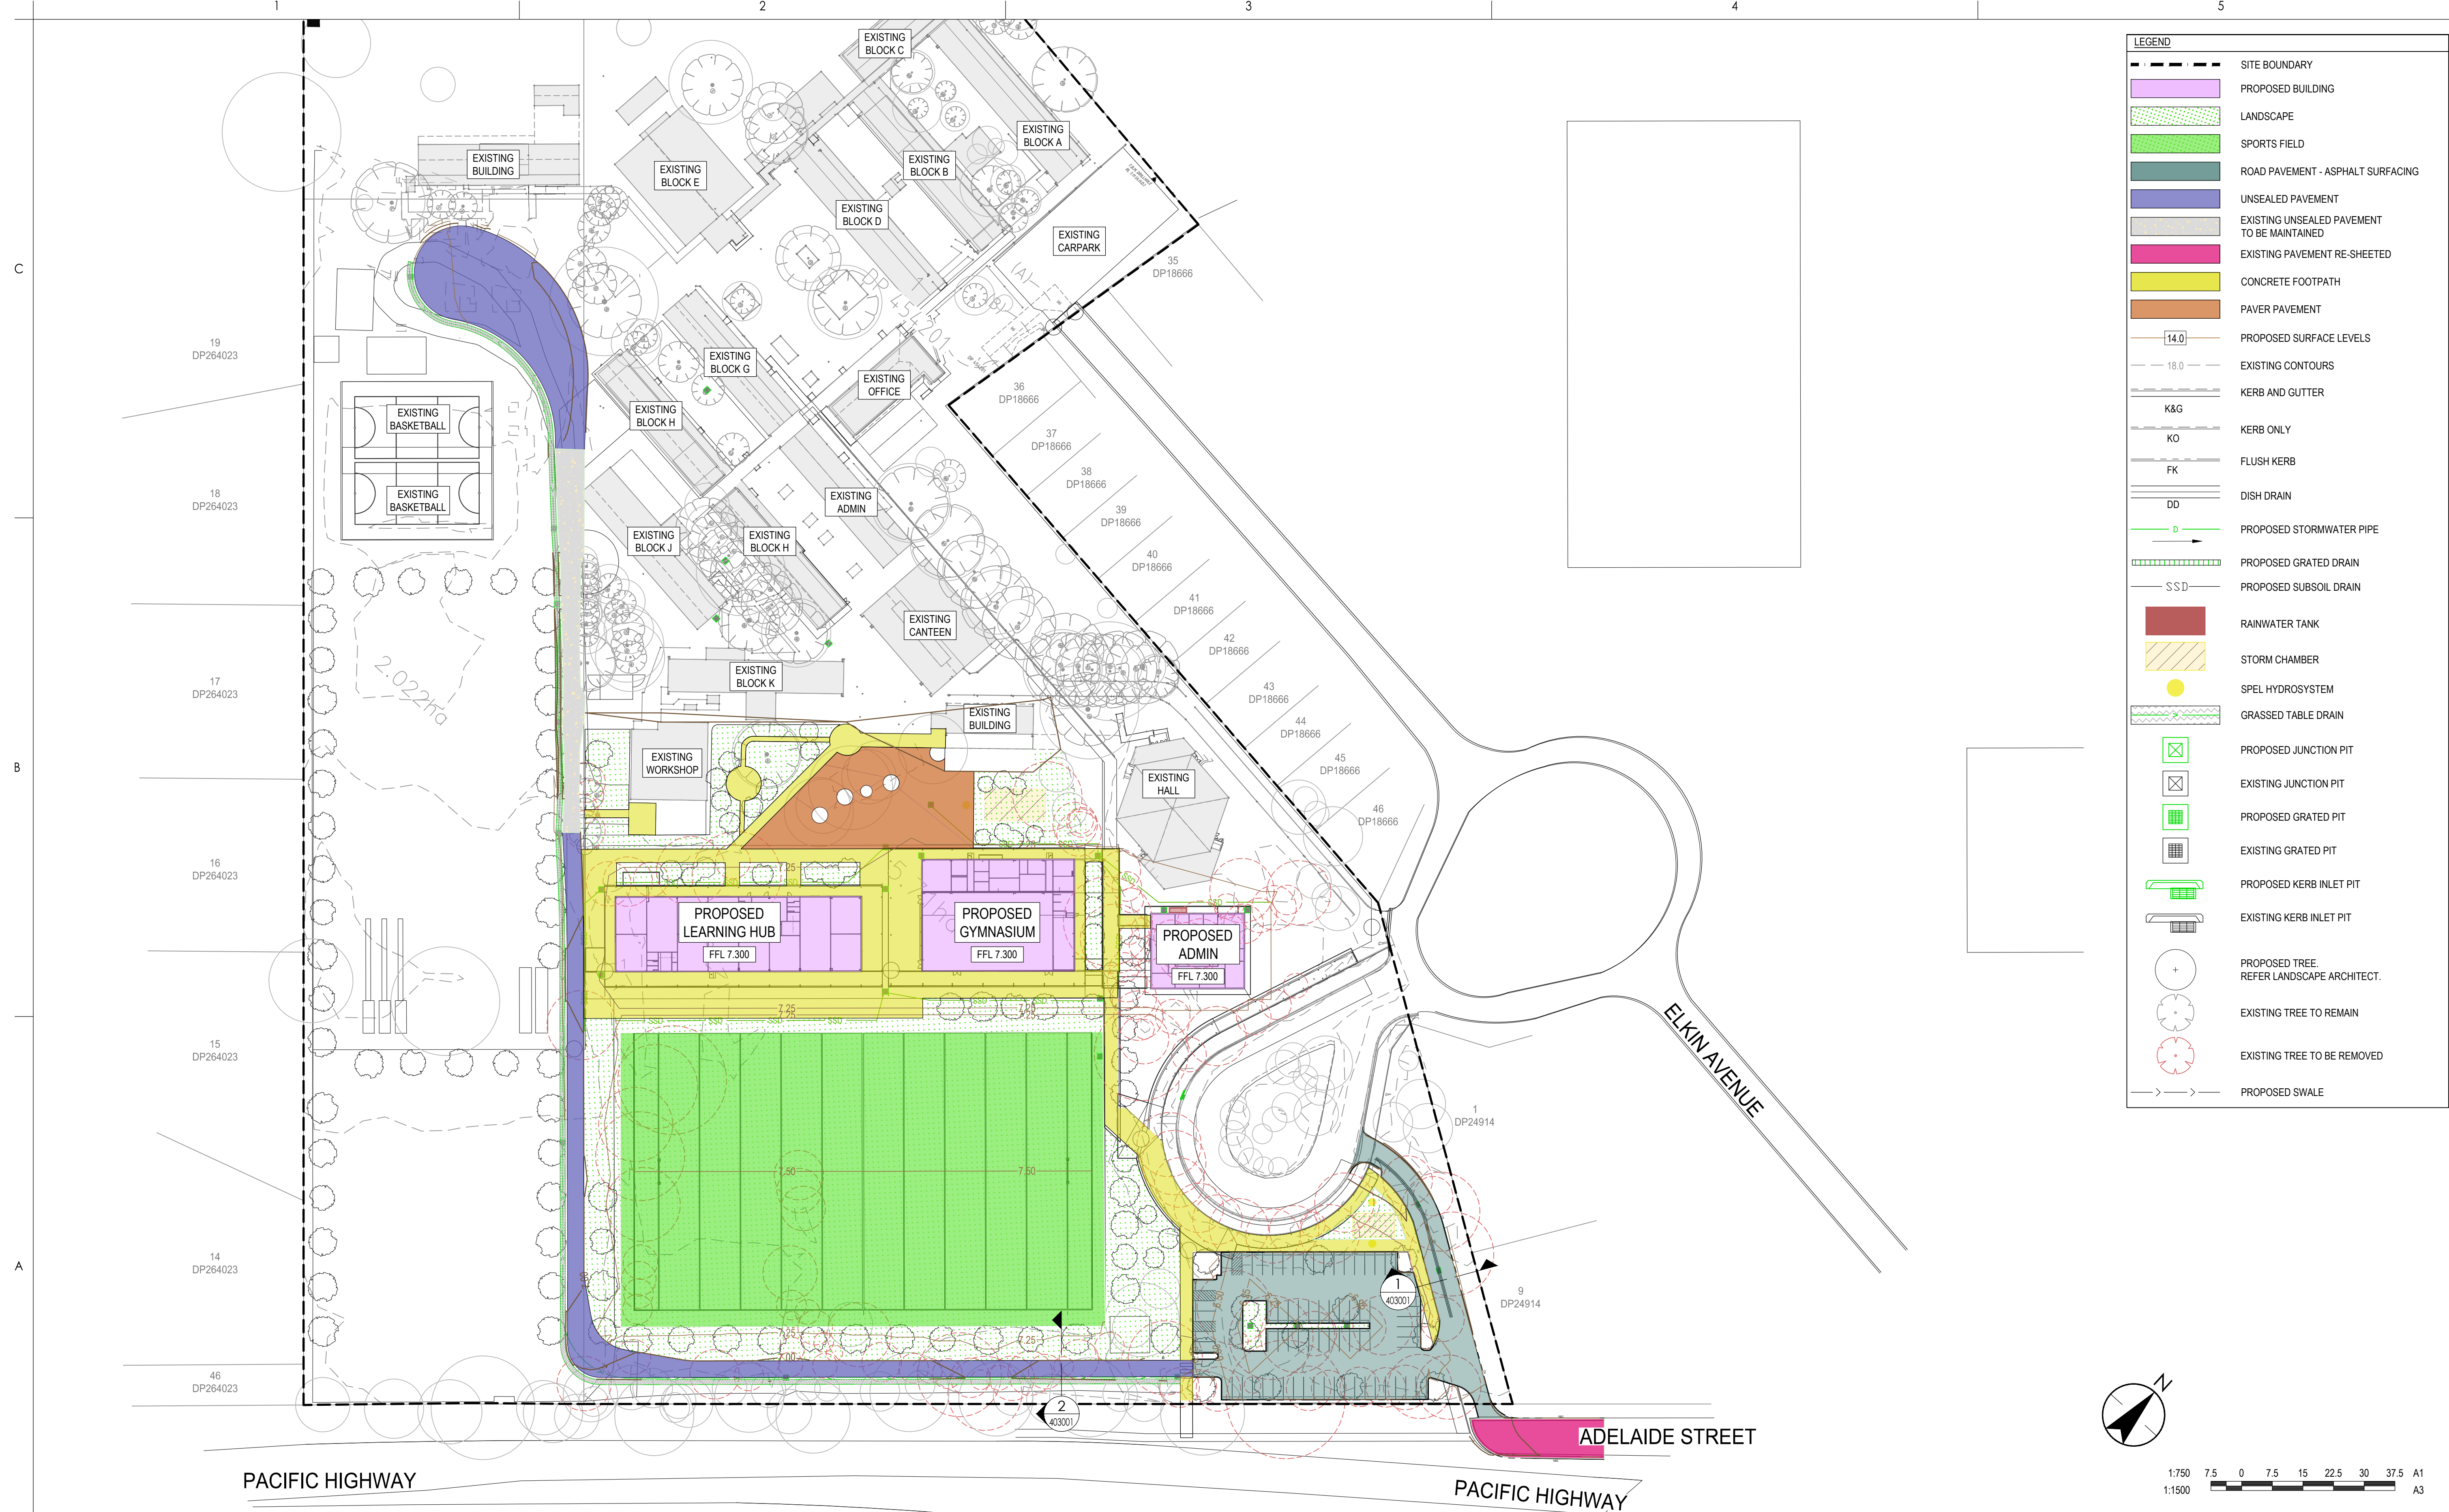

Notes

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**GENERAL ARRANGEMENT PLAN**

**SITE WIDE**

Project No.

Scale

1:750

Revision


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Drawing No.


**HRHS-STNC-XX-XX-DR-C-060001**

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UN30130099 PROJECT DOCUMENTATION DRAWINGS & DESIGN VIEWS SHEET SET





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**LEGEND**

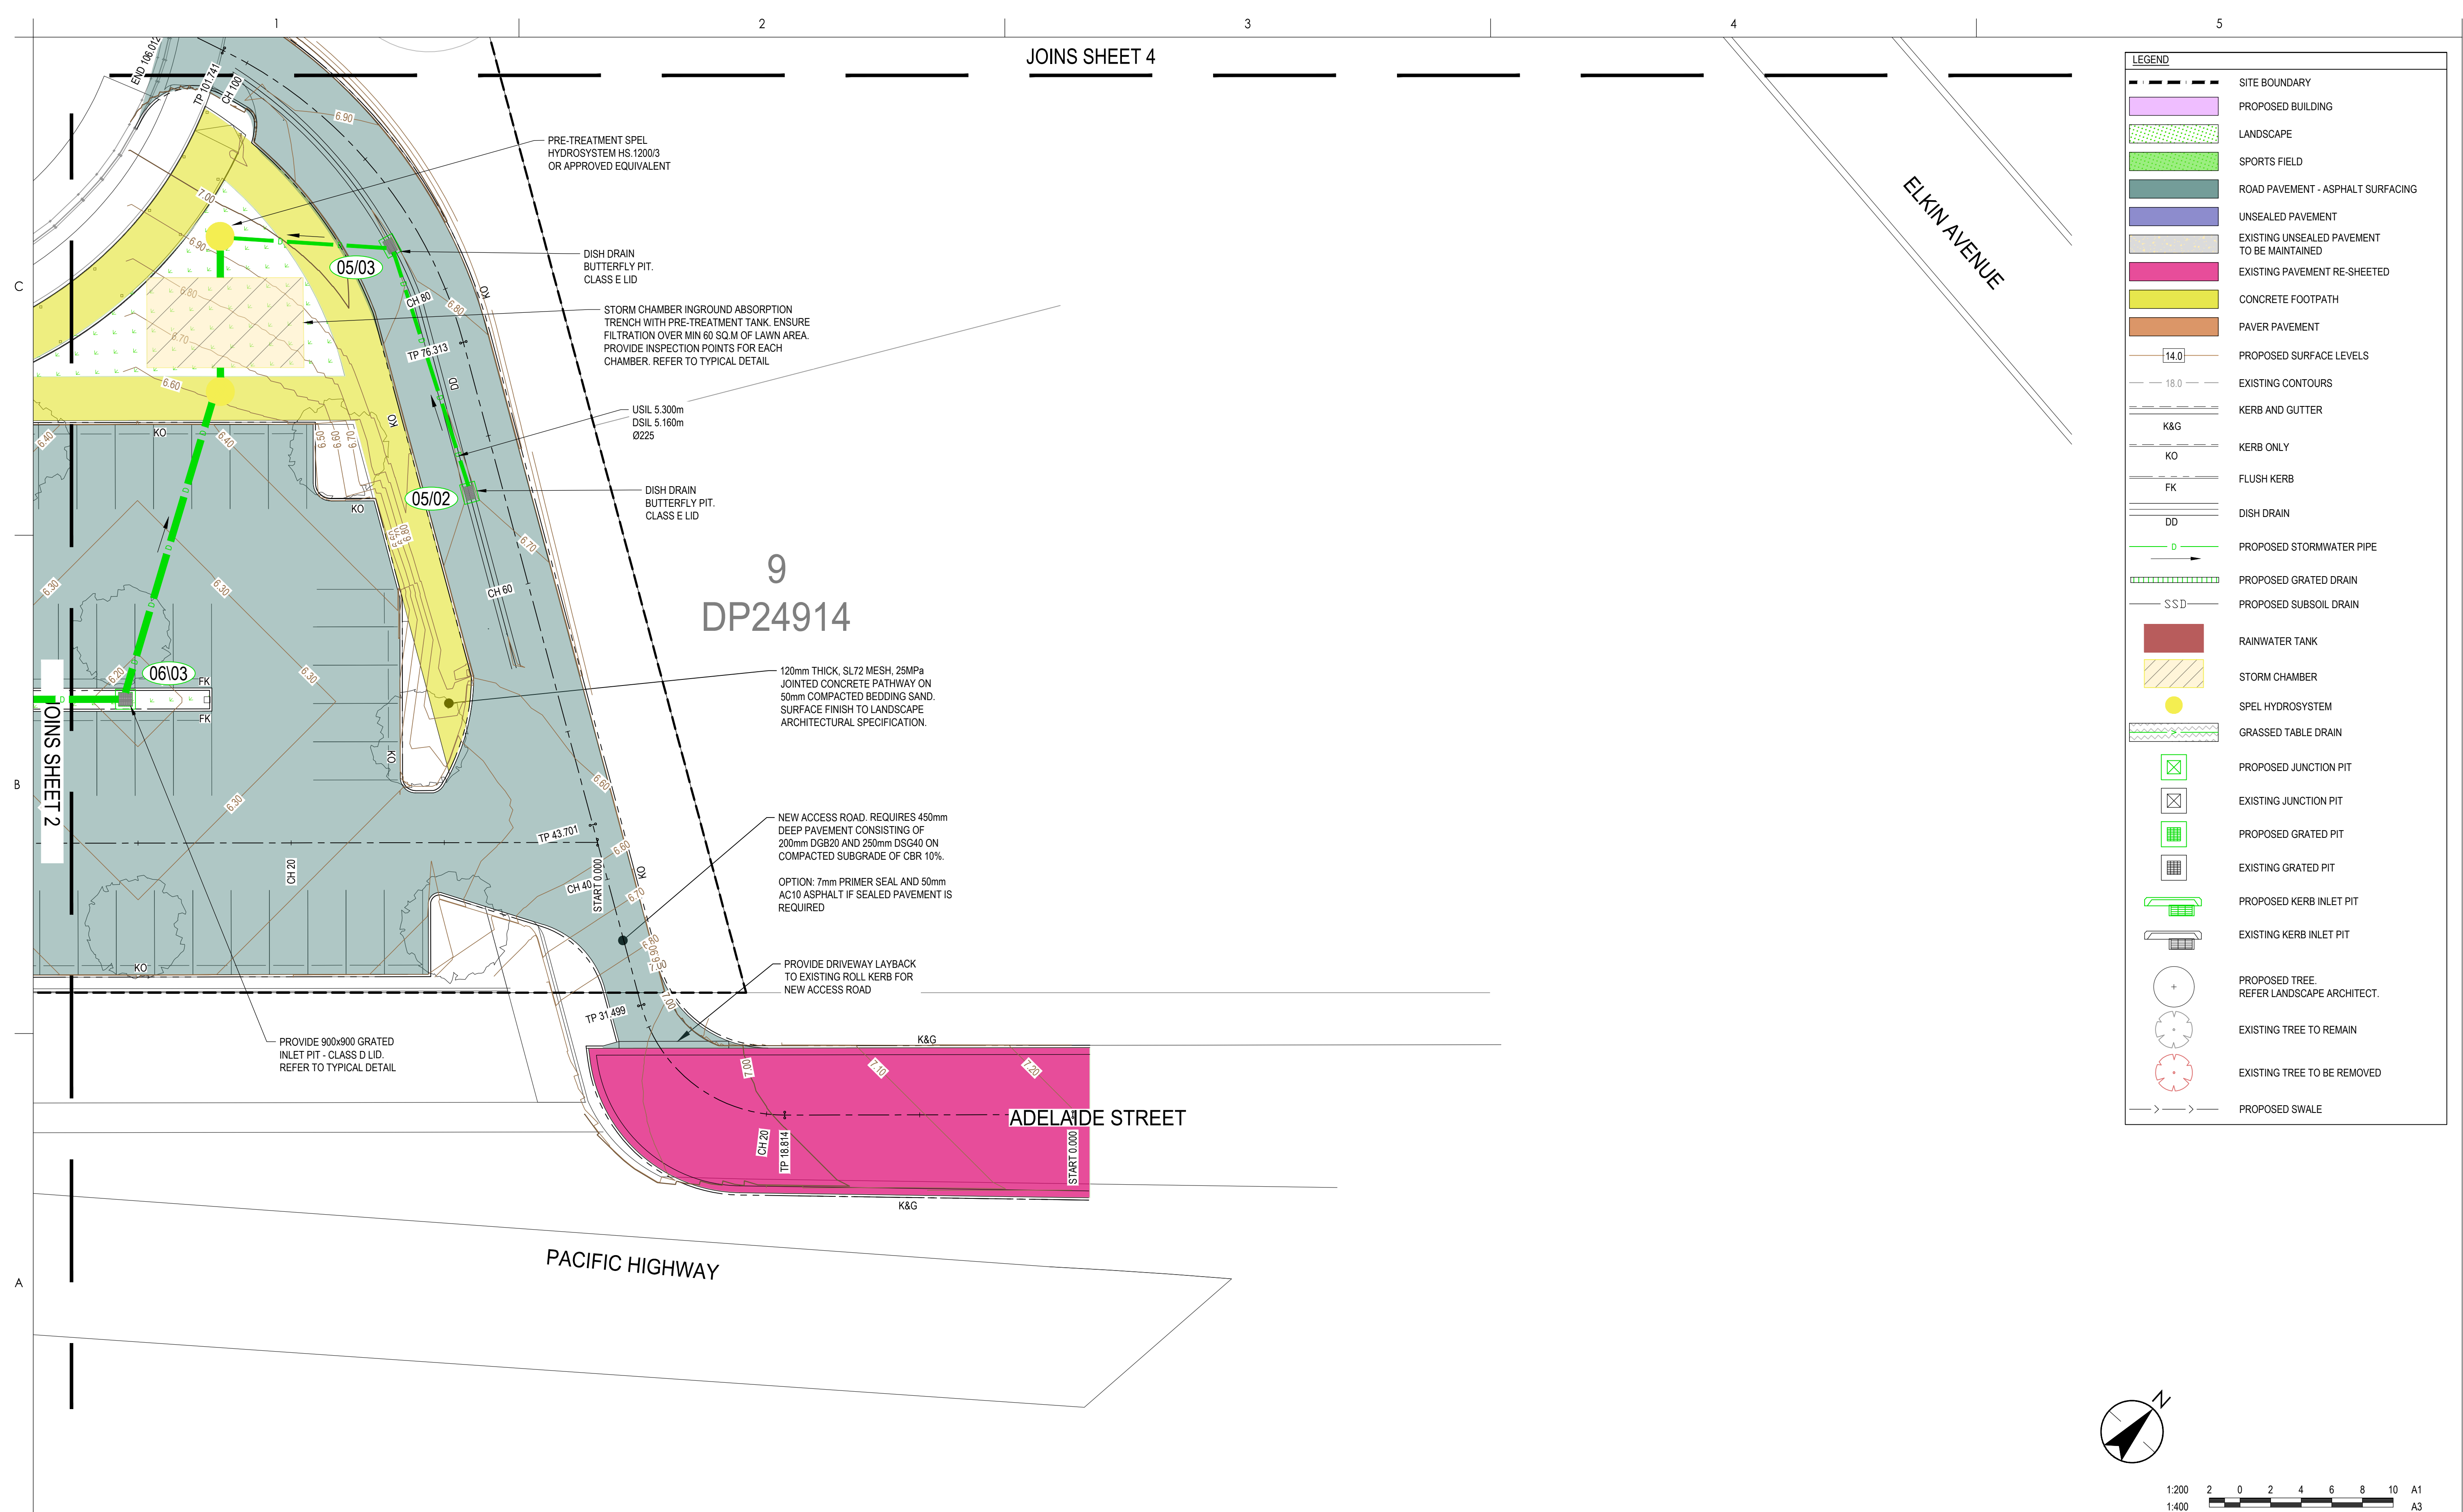- SITE BOUNDARY
- PROPOSED BUILDING
- LANDSCAPE
- SPORTS FIELD
- ROAD PAVEMENT - ASPHALT SURFACING
- UNSEALED PAVEMENT
- EXISTING UNSEALED PAVEMENT TO BE MAINTAINED
- EXISTING PAVEMENT RE-SHEETED
- CONCRETE FOOTPATH
- PAVER PAVEMENT
- PROPOSED SURFACE LEVELS
- EXISTING CONTOURS
- KERB AND GUTTER
- K&G
- KO
- FK
- DD
- PROPOSED STORMWATER PIPE
- PROPOSED GRATED DRAIN
- PROPOSED SUBSOIL DRAIN
- RAINWATER TANK
- STORM CHAMBER
- SPEL HYDROSYSTEM
- GRASSED TABLE DRAIN
- PROPOSED JUNCTION PIT
- EXISTING JUNCTION PIT
- PROPOSED GRATED PIT
- EXISTING GRATED PIT
- PROPOSED KERB INLET PIT
- EXISTING KERB INLET PIT
- PROPOSED TREE. REFER LANDSCAPE ARCHITECT.
- EXISTING TREE TO REMAIN
- EXISTING TREE TO BE REMOVED
- PROPOSED SWALE

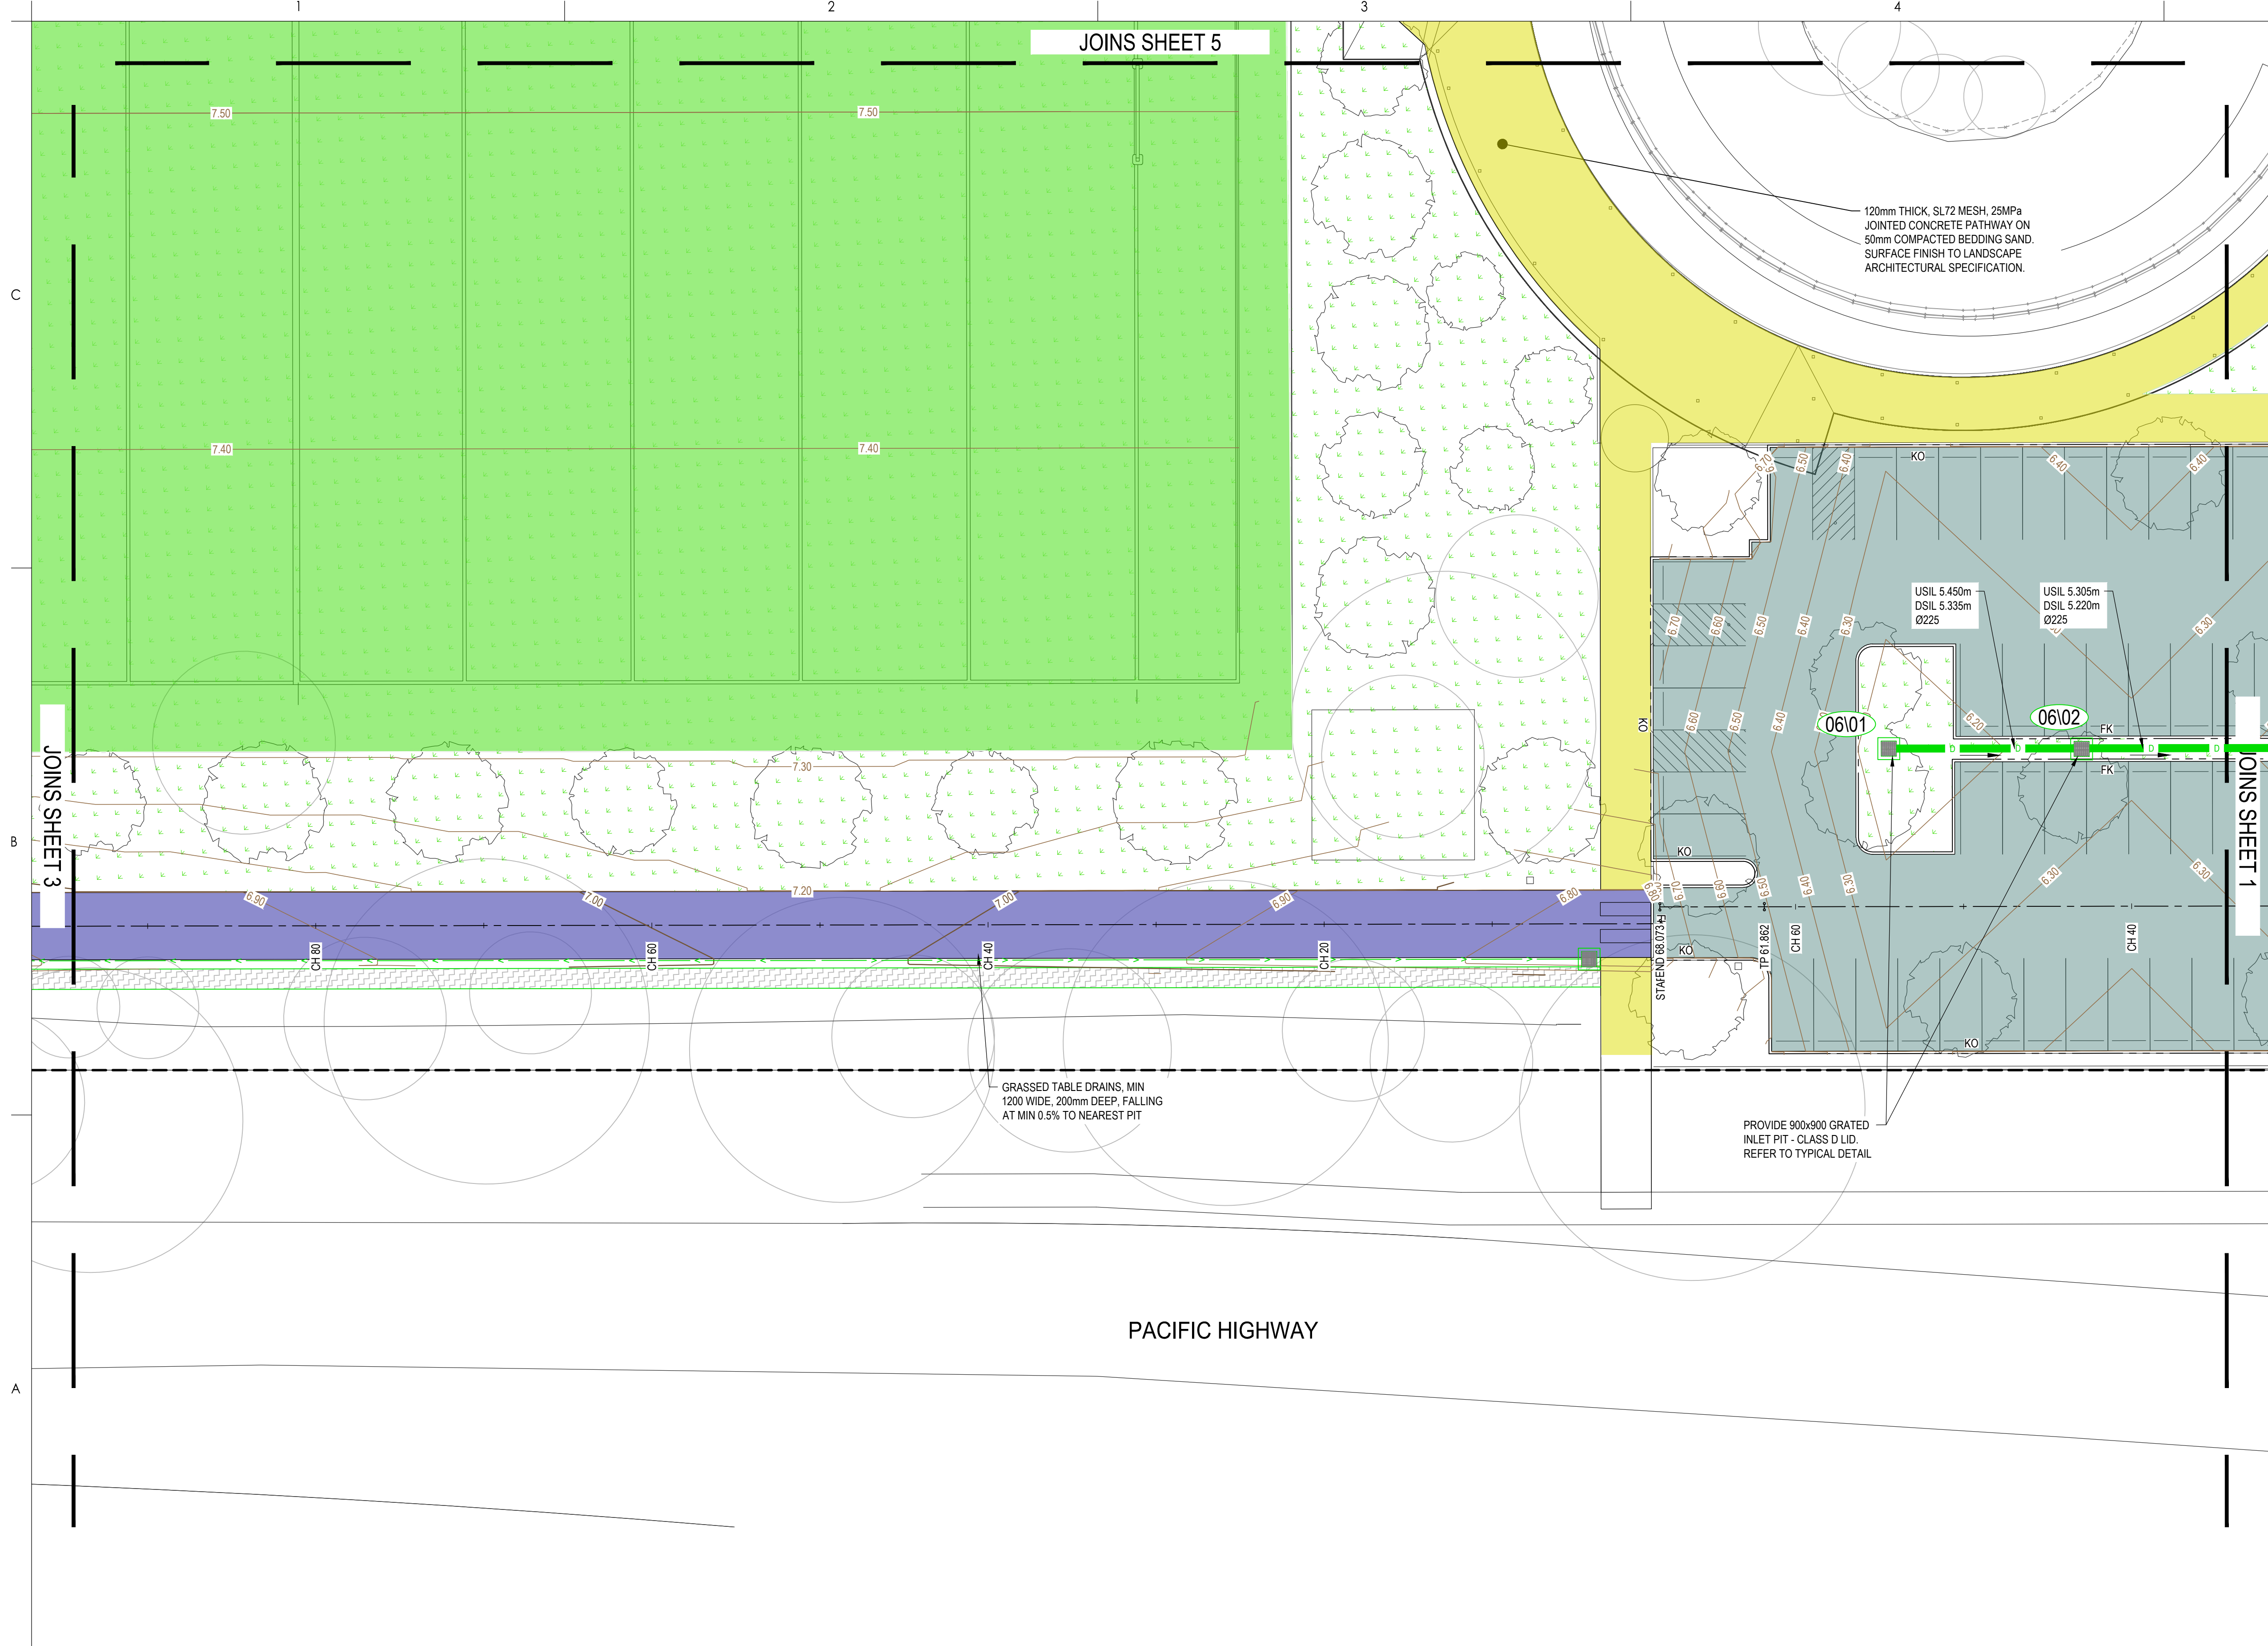

Notes

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Title

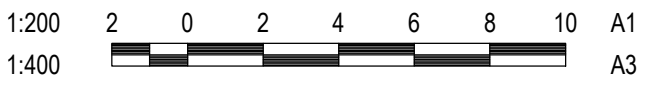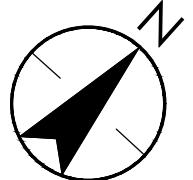SITWORKS PLAN-SHEET 2

Project No.

Scale

1:200

Revision

**G**

Drawing No.

**HRHS-STNC-XX-XX-DR-C-060102**

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JOINS SHEET 6

C

B



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PACIFIC HIGHWAY

JOINS SHEET 2

LEGEND

- SITE BOUNDARY
- PROPOSED BUILDING
- LANDSCAPE
- SPORTS FIELD
- ROAD PAVEMENT - ASPHALT SURFACING
- UNSEALED PAVEMENT
- EXISTING UNSEALED PAVEMENT TO BE MAINTAINED
- EXISTING PAVEMENT RE-SHEETED
- CONCRETE FOOTPATH
- PAVER PAVEMENT
- PROPOSED SURFACE LEVELS
- EXISTING CONTOURS
- KERB AND GUTTER
- K&G
- KO
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- DD
- PROPOSED STORMWATER PIPE
- PROPOSED GRATED DRAIN
- PROPOSED SUBSOIL DRAIN
- RAINWATER TANK
- STORM CHAMBER
- SPEL HYDROSYSTEM
- GRASSED TABLE DRAIN
- PROPOSED JUNCTION PIT
- EXISTING JUNCTION PIT
- PROPOSED GRATED PIT
- EXISTING GRATED PIT
- PROPOSED KERB INLET PIT
- EXISTING KERB INLET PIT
- PROPOSED TREE. REFER LANDSCAPE ARCHITECT.
- EXISTING TREE TO REMAIN
- EXISTING TREE TO BE REMOVED
- PROPOSED SWALE

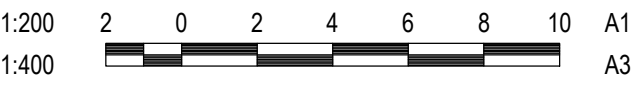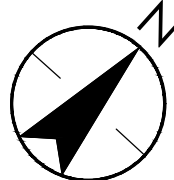

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Notes

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Title

SITeworks PLAN-SHEET 3

Project No.

Scale

1:200

Revision

Drawing No.

**HRHS-STNC-XX-XX-DR-C-060103**

Stantec

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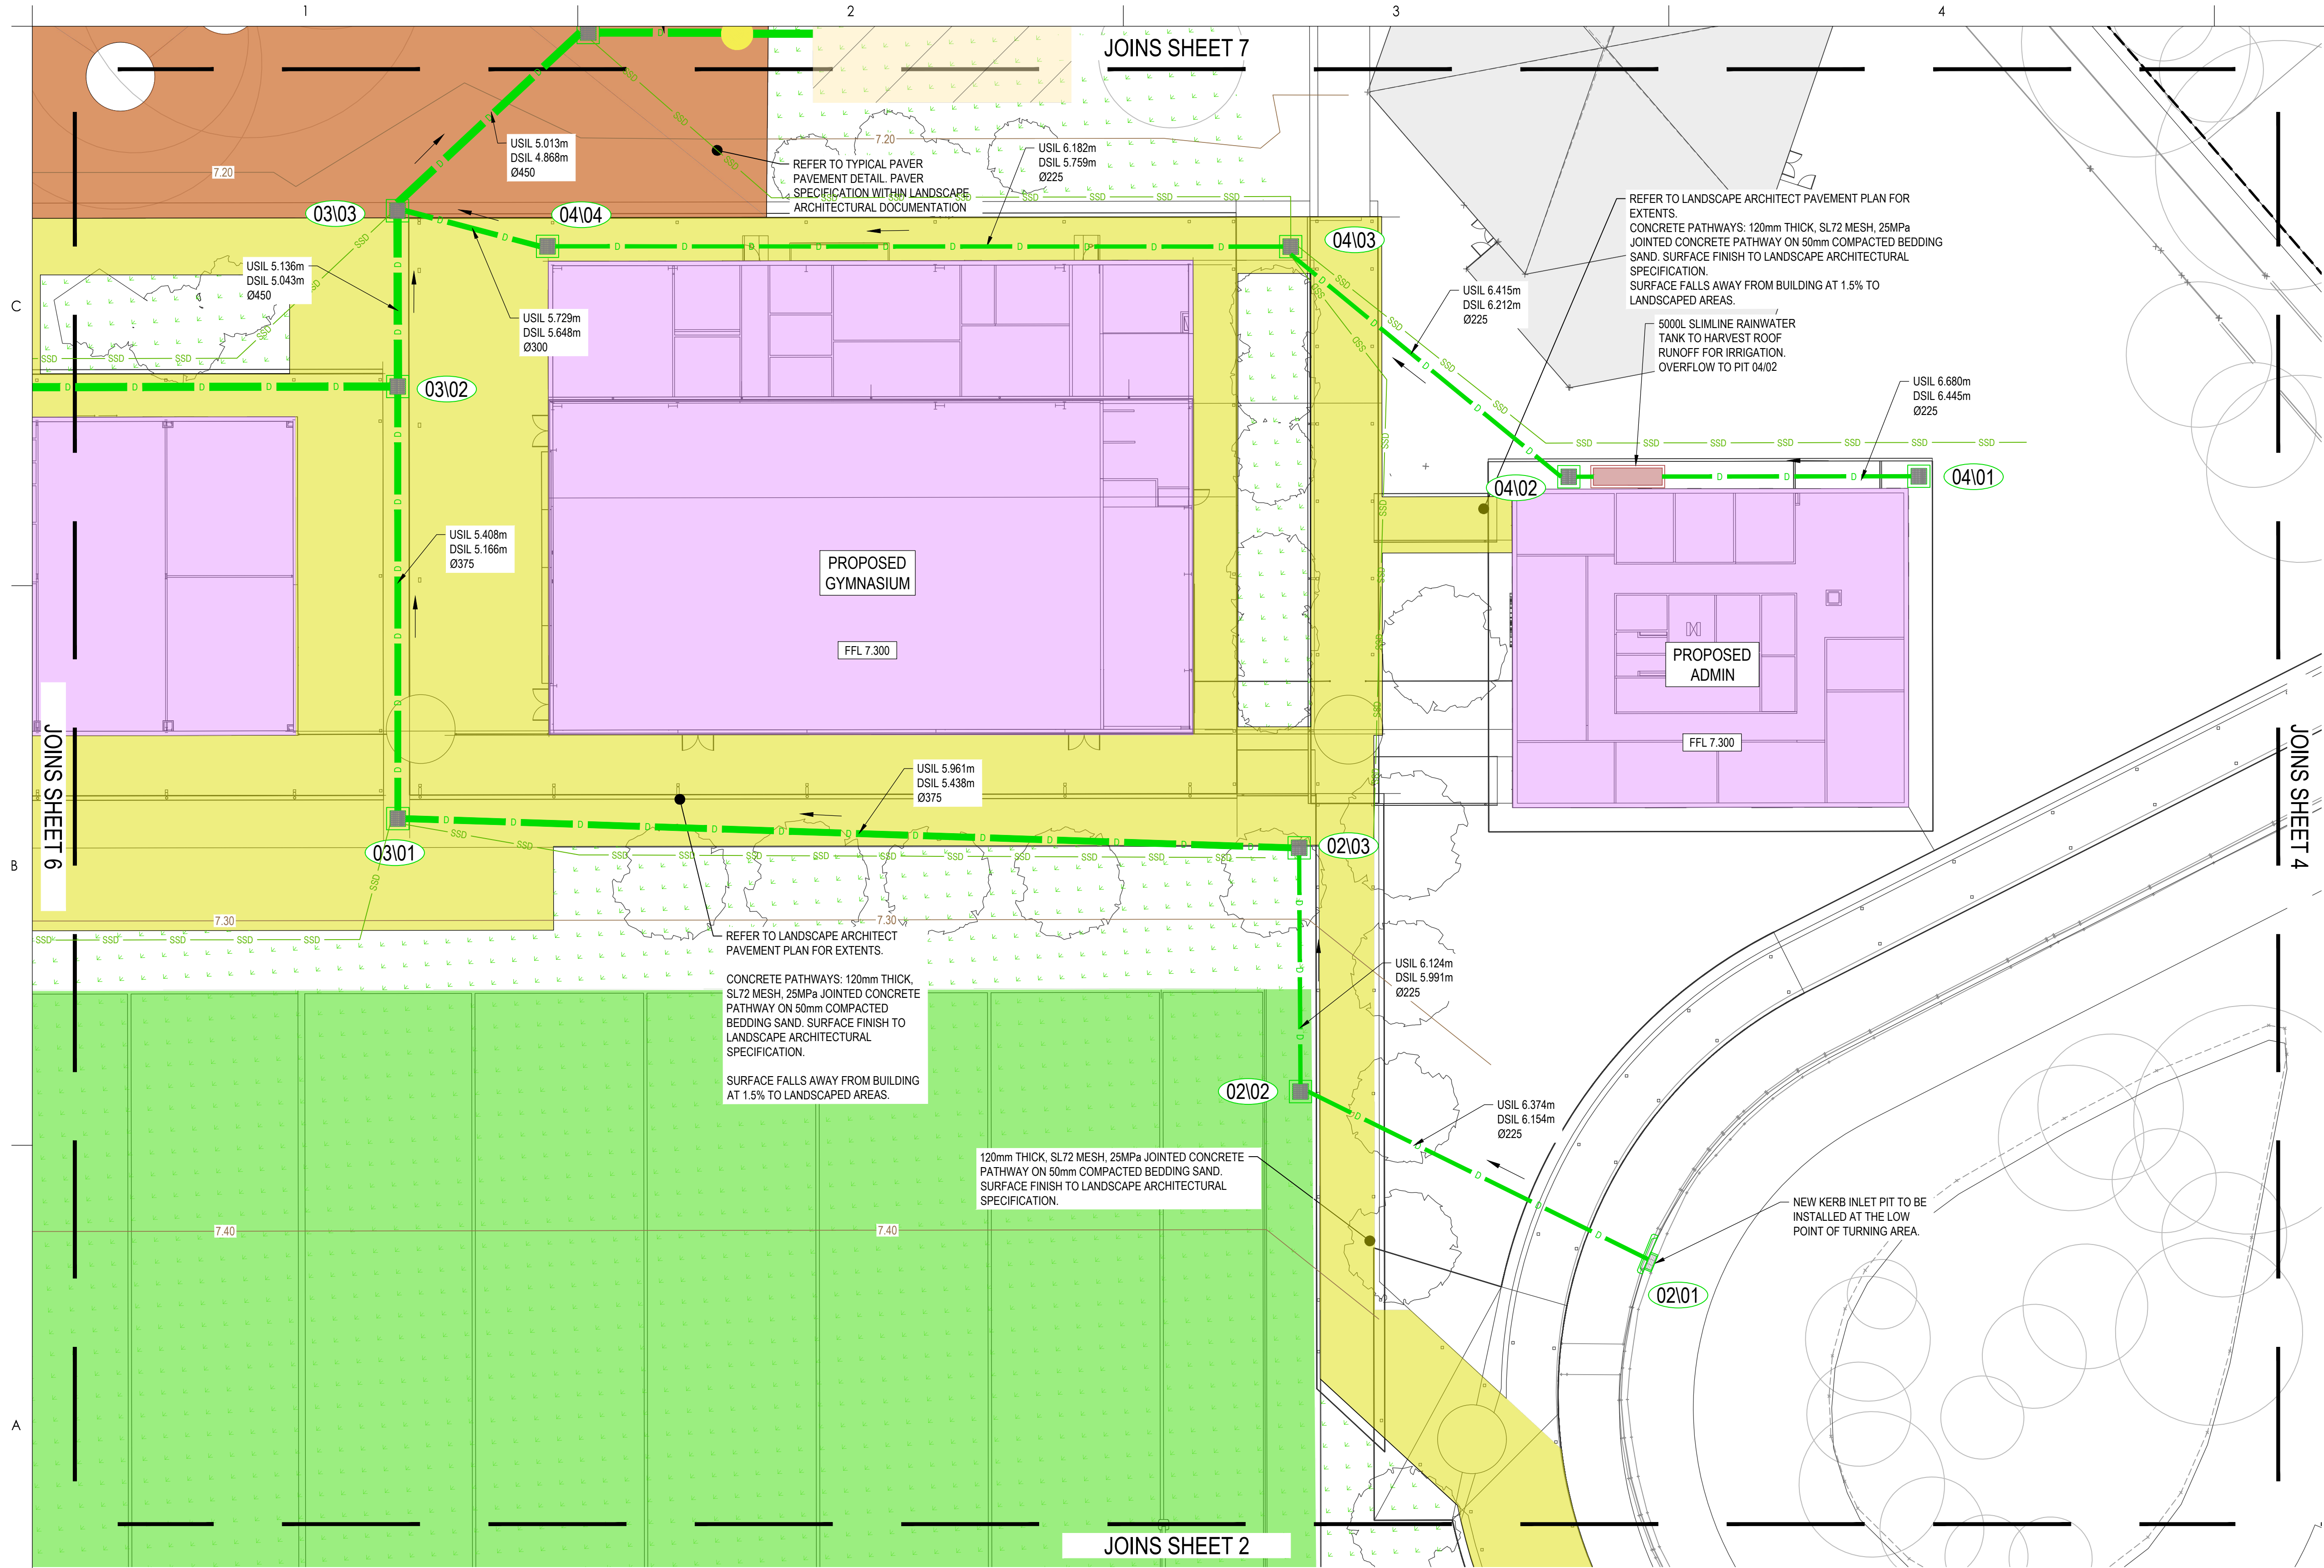
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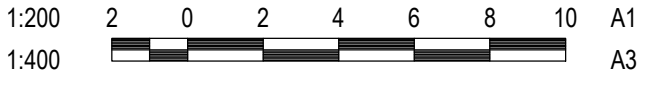
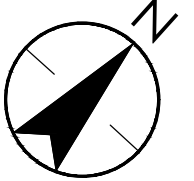








LEGEND	
	SITE BOUNDARY
	PROPOSED BUILDING
	LANDSCAPE
	SPORTS FIELD
	ROAD PAVEMENT - ASPHALT SURFACING
	UNSEALED PAVEMENT
	EXISTING UNSEALED PAVEMENT TO BE MAINTAINED
	EXISTING PAVEMENT RE-SHEETED
	CONCRETE FOOTPATH
	PAVER PAVEMENT
	PROPOSED SURFACE LEVELS
	EXISTING CONTOURS
	KERB AND GUTTER
	KERB ONLY
	FLUSH KERB
	DISH DRAIN
	PROPOSED STORMWATER PIPE
	PROPOSED GRATED DRAIN
	PROPOSED SUBSOIL DRAIN
	RAINWATER TANK
	STORM CHAMBER
	SPEL HYDROSYSTEM
	GRASSED TABLE DRAIN
	PROPOSED JUNCTION PIT
	EXISTING JUNCTION PIT
	PROPOSED GRATED PIT
	EXISTING GRATED PIT
	PROPOSED KERB INLET PIT
	EXISTING KERB INLET PIT
	PROPOSED TREE. REFER LANDSCAPE ARCHITECT.
	EXISTING TREE TO REMAIN
	EXISTING TREE TO BE REMOVED
	PROPOSED SWALE



Notes

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HEATHERBRAE NSW 2324

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Title

SITeworks PLAN-SHEET 5

Project No.

Scale

1:200

Revision

Drawing No.

HRHS-STNC-XX-XX-DR-C-060105

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## JOINS SHEET 8

## JOINS SHEET 3

REFER TO LANDSCAPE ARCHITECT PAVEMENT PLAN FOR EXTENTS.

CONCRETE PATHWAYS: 120mm THICK, SL72 MESH, 25MPa JOINTED CONCRETE PATHWAY ON 50mm COMPACTED BEDDING SAND. SURFACE FINISH TO LANDSCAPE ARCHITECTURAL SPECIFICATION.

SURFACE FALLS AWAY FROM BUILDING AT 1.5% TO LANDSCAPED AREAS.

GRASSED TABLE DRAINS, MIN 1200 WIDE, 200mm DEEP, FALLING AT MIN 0.5% TO NEAREST PIT

900x900 1000mm DEEP STORMWATER PITS WITH CLASS D GALV GRATING. PROVIDE ATLANTIS CELL AT BASE OF PIT FOR ABSORPTION.

100mm SUBSOIL LINES AT MIN COVER, FALLING AT MIN 0.5% TO BE PROVIDED AROUND BUILDING PAVEMENT EXTENTS. DISCHARGE TO NEAREST INLET PIT. PROVIDE INSPECTION POINTS AT MIN 15m CENTRES.

REFER TO TYPICAL PAVER PAVEMENT DETAIL. PAVER SPECIFICATION WITHIN LANDSCAPE ARCHITECTURAL DOCUMENTATION

USIL 6.452m  
DSIL 5.765m  
Ø450


USIL 6.680m  
DSIL 6.482m  
Ø225

PROPOSED  
LEARNING HUB

FFL 7.300

100mm SUBSOIL LINES AT MIN COVER, FALLING AT MIN 0.5% TO BE PROVIDED AROUND BUILDING PAVEMENT EXTENTS. DISCHARGE TO NEAREST INLET PIT. PROVIDE INSPECTION POINTS AT MIN 15m CENTRES.

LEGEND	
	SITE BOUNDARY
	PROPOSED BUILDING
	LANDSCAPE
	SPORTS FIELD
	ROAD PAVEMENT - ASPHALT SURFACING
	UNSEALED PAVEMENT
	EXISTING UNSEALED PAVEMENT TO BE MAINTAINED
	EXISTING PAVEMENT RE-SHEETED
	CONCRETE FOOTPATH
	PAVER PAVEMENT
	PROPOSED SURFACE LEVELS
	EXISTING CONTOURS
	KERB AND GUTTER
	KERB ONLY
	FLUSH KERB
	DISH DRAIN
	PROPOSED STORMWATER PIPE
	PROPOSED GRATED DRAIN
	PROPOSED SUBSOIL DRAIN
	RAINWATER TANK
	STORM CHAMBER
	SPEL HYDROSYSTEM
	GRASSED TABLE DRAIN
	PROPOSED JUNCTION PIT
	EXISTING JUNCTION PIT
	PROPOSED GRATED PIT
	EXISTING GRATED PIT
	PROPOSED KERB INLET PIT
	EXISTING KERB INLET PIT
	PROPOSED TREE. REFER LANDSCAPE ARCHITECT.
	EXISTING TREE TO REMAIN
	EXISTING TREE TO BE REMOVED
	PROPOSED SWALE

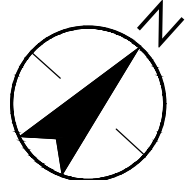

1:200 2 0 2 4 6 8 10 A1  
1:400 A3

## Notes

G	REVISED SCHEMATIC DESIGN	BCH	JMB	2023.09.01
F	REVISED SCHEMATIC DESIGN	LPT	JMB	2023.07.14
E	REVISED SCHEMATIC DESIGN	CPO	JMB	2023.04.13
D	DRAFT REVISED SCHEMATIC DESIGN ISSUE	CPO	JMB	2023.03.24
C	FINAL PHASE 3 ISSUE	CPO	JMB	2022.08.08
B	100% SCHEMATIC DESIGN PROCESS	CPO	JMB	2022.07.29
A	95% SCHEMATIC DESIGN PROCESS	CPO	JMB	2022.07.14
Issued/Revision		By	Appd	YYYY.MM.DD

## Issue Status

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## Client/Project Logo



## Client/Project

SINSW

HUNTERS RIVER HIGH SCHOOL

HEATHERBRAE NSW 2324

File Name:	HRHS-STNC-XX-XX-DR-C-060101.DWG	CPO	JMB	JMB	2022.07.14
		Dwn.	Dign.	Chkd.	YYYY.MM.DD

## Title

SITeworks PLAN-SHEET 6

## Project No.


## Scale

1:200

Revision  
**G**

Drawing No.  
**HRHS-STNC-XX-XX-DR-C-060106**



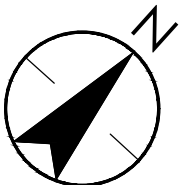


Drawing No.  
**HRHS-STNC-XX-XX-DR-C-060107**









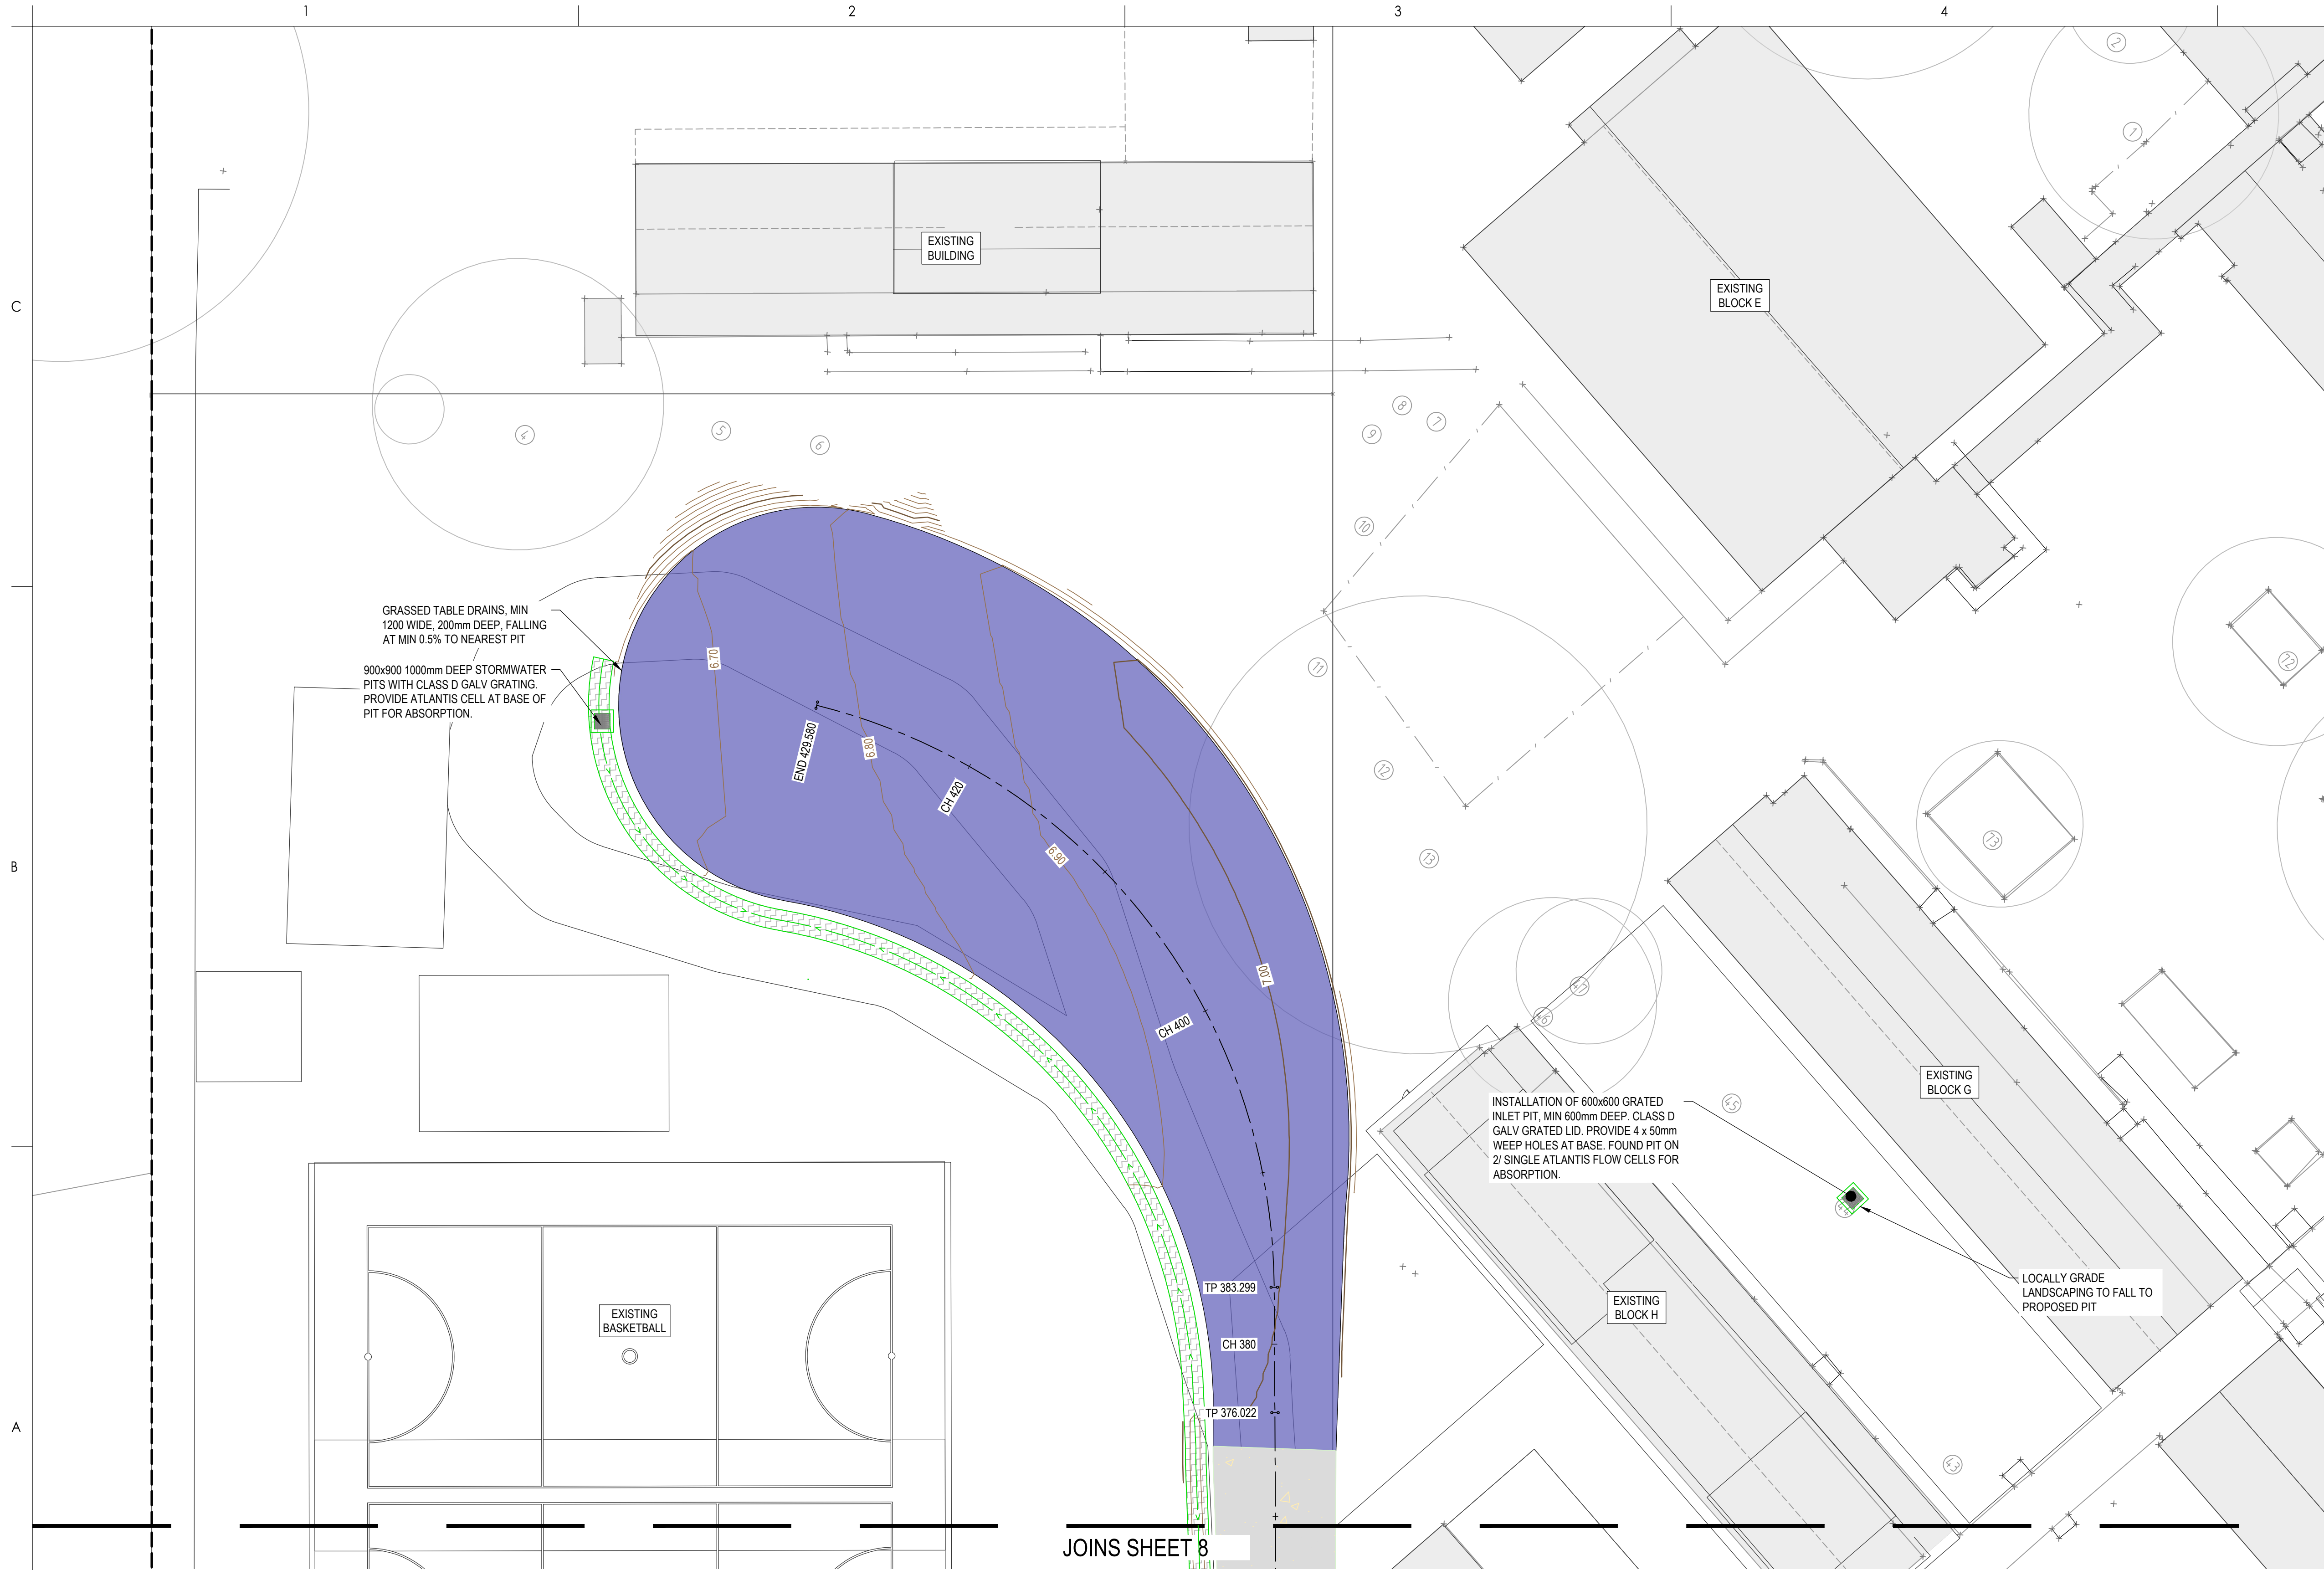

LEGEND	
	SITE BOUNDARY
	PROPOSED BUILDING
	LANDSCAPE
	SPORTS FIELD
	ROAD PAVEMENT - ASPHALT SURFACING
	UNSEALED PAVEMENT
	EXISTING UNSEALED PAVEMENT TO BE MAINTAINED
	EXISTING PAVEMENT RE-SHEETED
	CONCRETE FOOTPATH
	PAVER PAVEMENT
	PROPOSED SURFACE LEVELS
	EXISTING CONTOURS
	KERB AND GUTTER
	KERB ONLY
	FLUSH KERB
	DISH DRAIN
	PROPOSED STORMWATER PIPE
	PROPOSED GRATED DRAIN
	PROPOSED SUBSOIL DRAIN
	RAINWATER TANK
	STORM CHAMBER
	SPEL HYDROSYSTEM
	GRASSED TABLE DRAIN
	PROPOSED JUNCTION PIT
	EXISTING JUNCTION PIT
	PROPOSED GRATED PIT
	EXISTING GRATED PIT
	PROPOSED KERB INLET PIT
	EXISTING KERB INLET PIT
	PROPOSED TREE. REFER LANDSCAPE ARCHITECT.
	EXISTING TREE TO REMAIN
	EXISTING TREE TO BE REMOVED
	PROPOSED SWALE

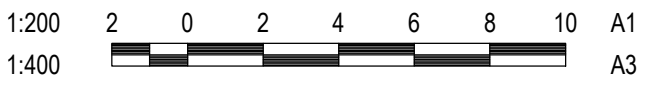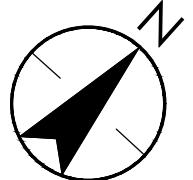

Notes

G	REVISED SCHEMATIC DESIGN	BCH	JMB	2023.09.01
F	REVISED SCHEMATIC DESIGN	LPT	JMB	2023.07.14
E	REVISED SCHEMATIC DESIGN	CPO	JMB	2023.04.13
D	DRAFT REVISED SCHEMATIC DESIGN ISSUE	CPO	JMB	2023.03.24
C	FINAL PHASE 3 ISSUE	CPO	JMB	2022.08.08
B	100% SCHEMATIC DESIGN PROCESS	CPO	JMB	2022.07.29
A	95% SCHEMATIC DESIGN PROCESS	CPO	JMB	2022.07.14

Issued/Revision

By

Appd

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Client/Project Logo

Education  
School Infrastructure

Client/Project

SINSW

HUNTERS RIVER HIGH SCHOOL

HEATHERBRAE NSW 2324

File Name: HRHS-STNC-XX-XX-DR-C-060101.DWG

CPO	JMB	JMB	2022.07.14
Dwn.	Dign.	Chkd.	YYYY.MM.DD

Title

SITWORKS PLAN-SHEET 9

Project No.

Scale

1:200

Revision

Drawing No.

HRHS-STNC-XX-XX-DR-C-060109

Plotted: 01:56:02 24.03.24 PM By: HCONTI\_BBU  
UNITS: 1000 PROJECT DOCUMENTATION DRAWINGS & DESIGN VIEWS SHEET SET

















C

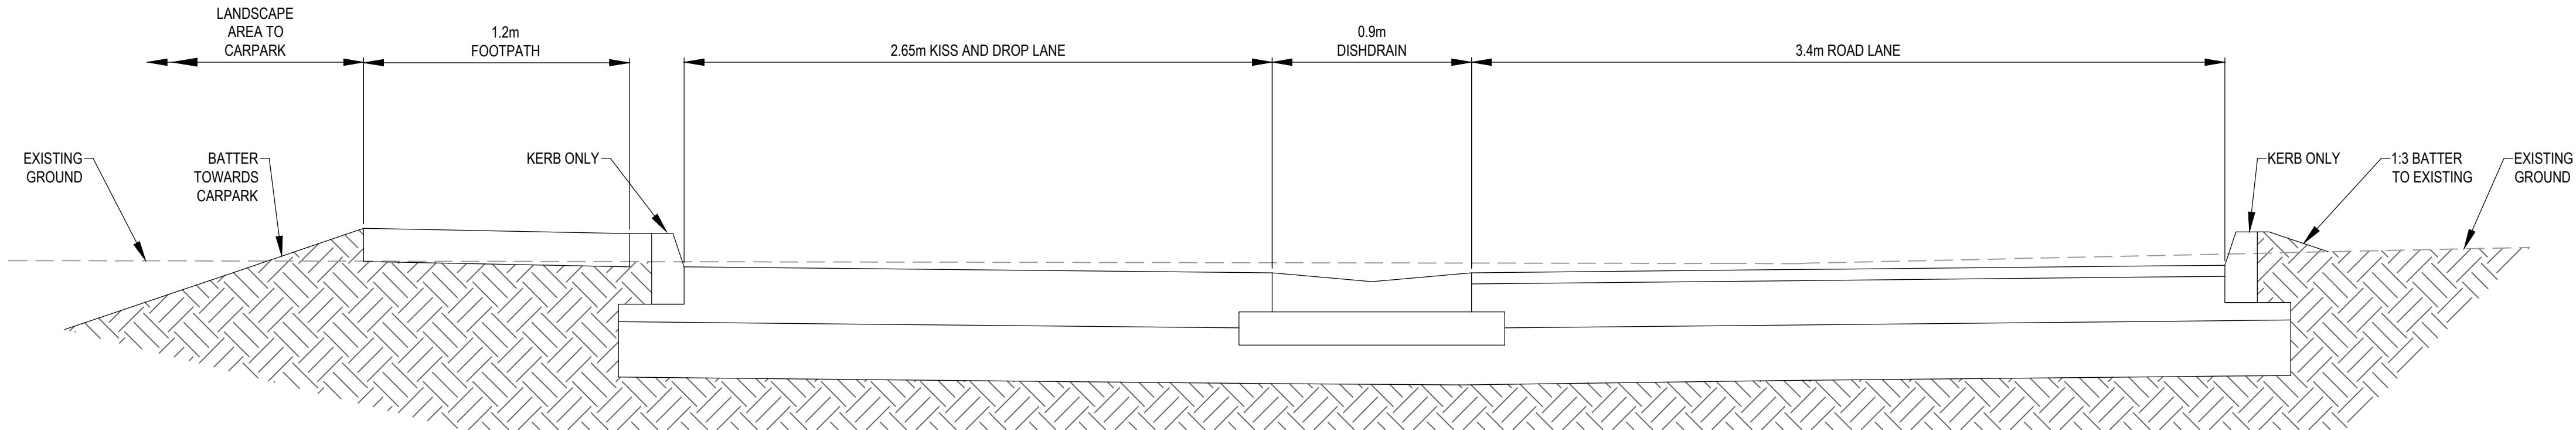


SECTION 1  
SCALE 1:20

B

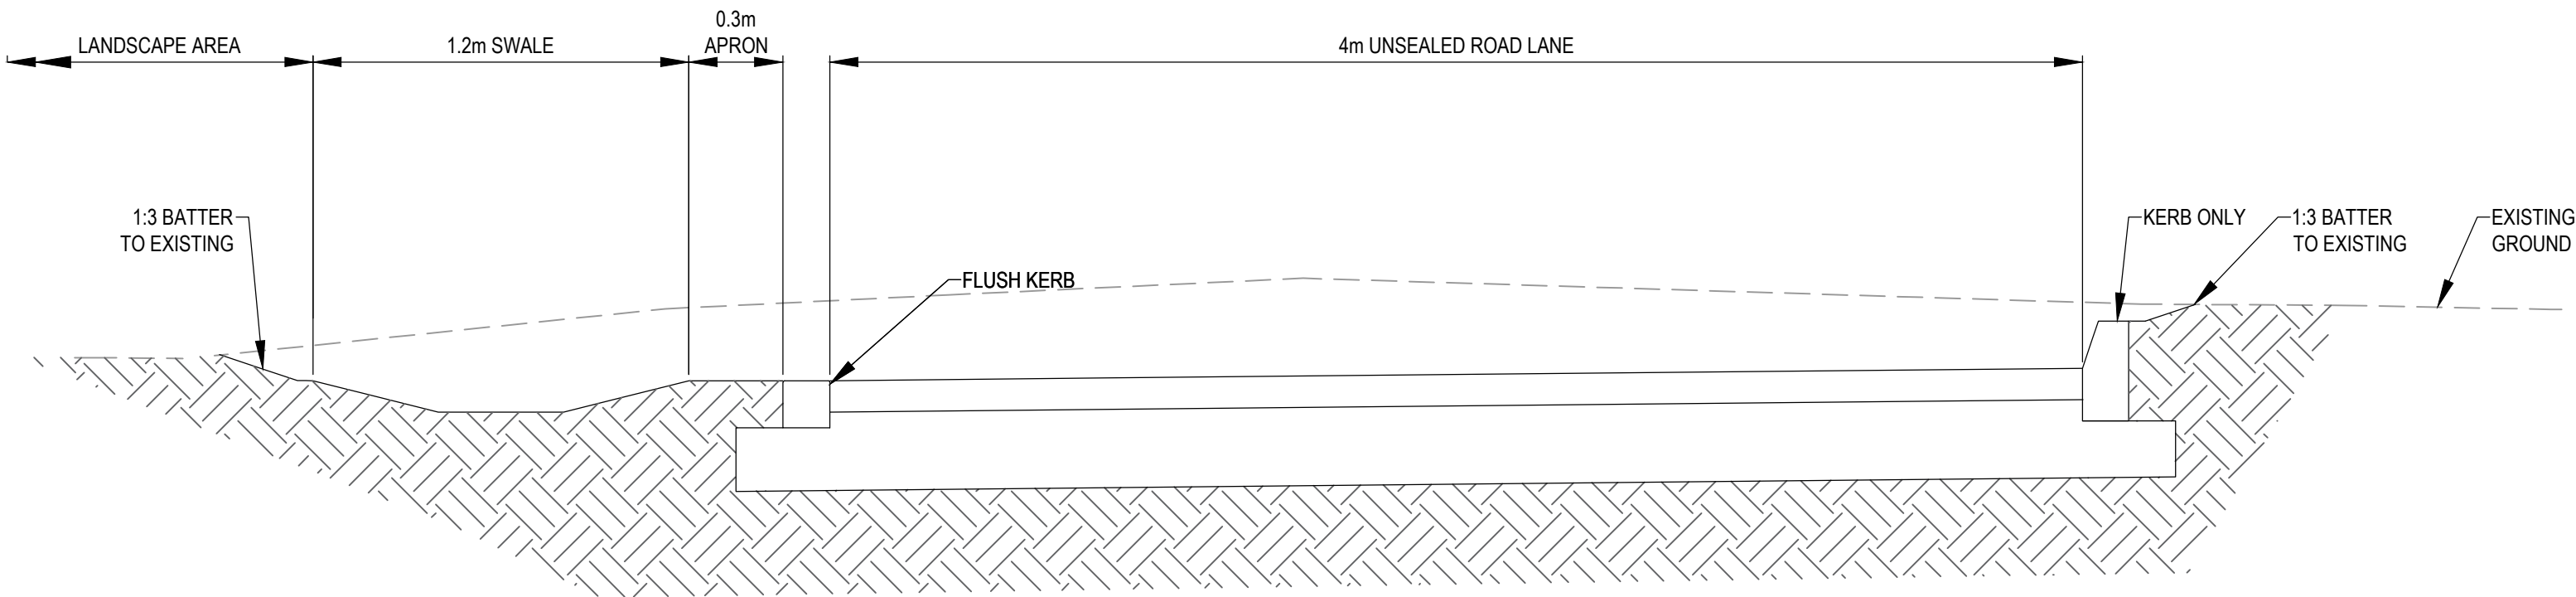

SECTION 2  
SCALE 1:20

A

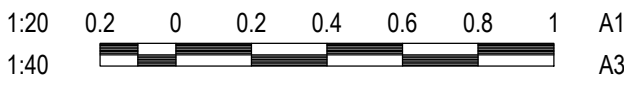

Notes

D	REVISED SCHEMATIC DESIGN	CPO	JMB	2023.04.13
C	DRAFT REVISED SCHEMATIC DESIGN ISSUE	CPO	JMB	2023.03.24
B	FINAL PHASE 3 ISSUE	CPO	JMB	2022.08.08
A	100% SCHEMATIC DESIGN PROCESS	CPO	JMB	2022.07.29

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Client/Project Logo

Client/Project

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HEATHERBRAE NSW 2324

File Name: HRHS-STNC-XX-XX-DR-C-403001.DWG

CPO	JMB	JMB	2022.07.29
Dwn.	Dign.	Chkd.	YYYY.MM.DD

Title

ROADS TYPICAL SECTIONS

Project No.

Scale

1:20

Revision

D

Drawing No.

HRHS-STNC-XX-XX-DR-C-403001














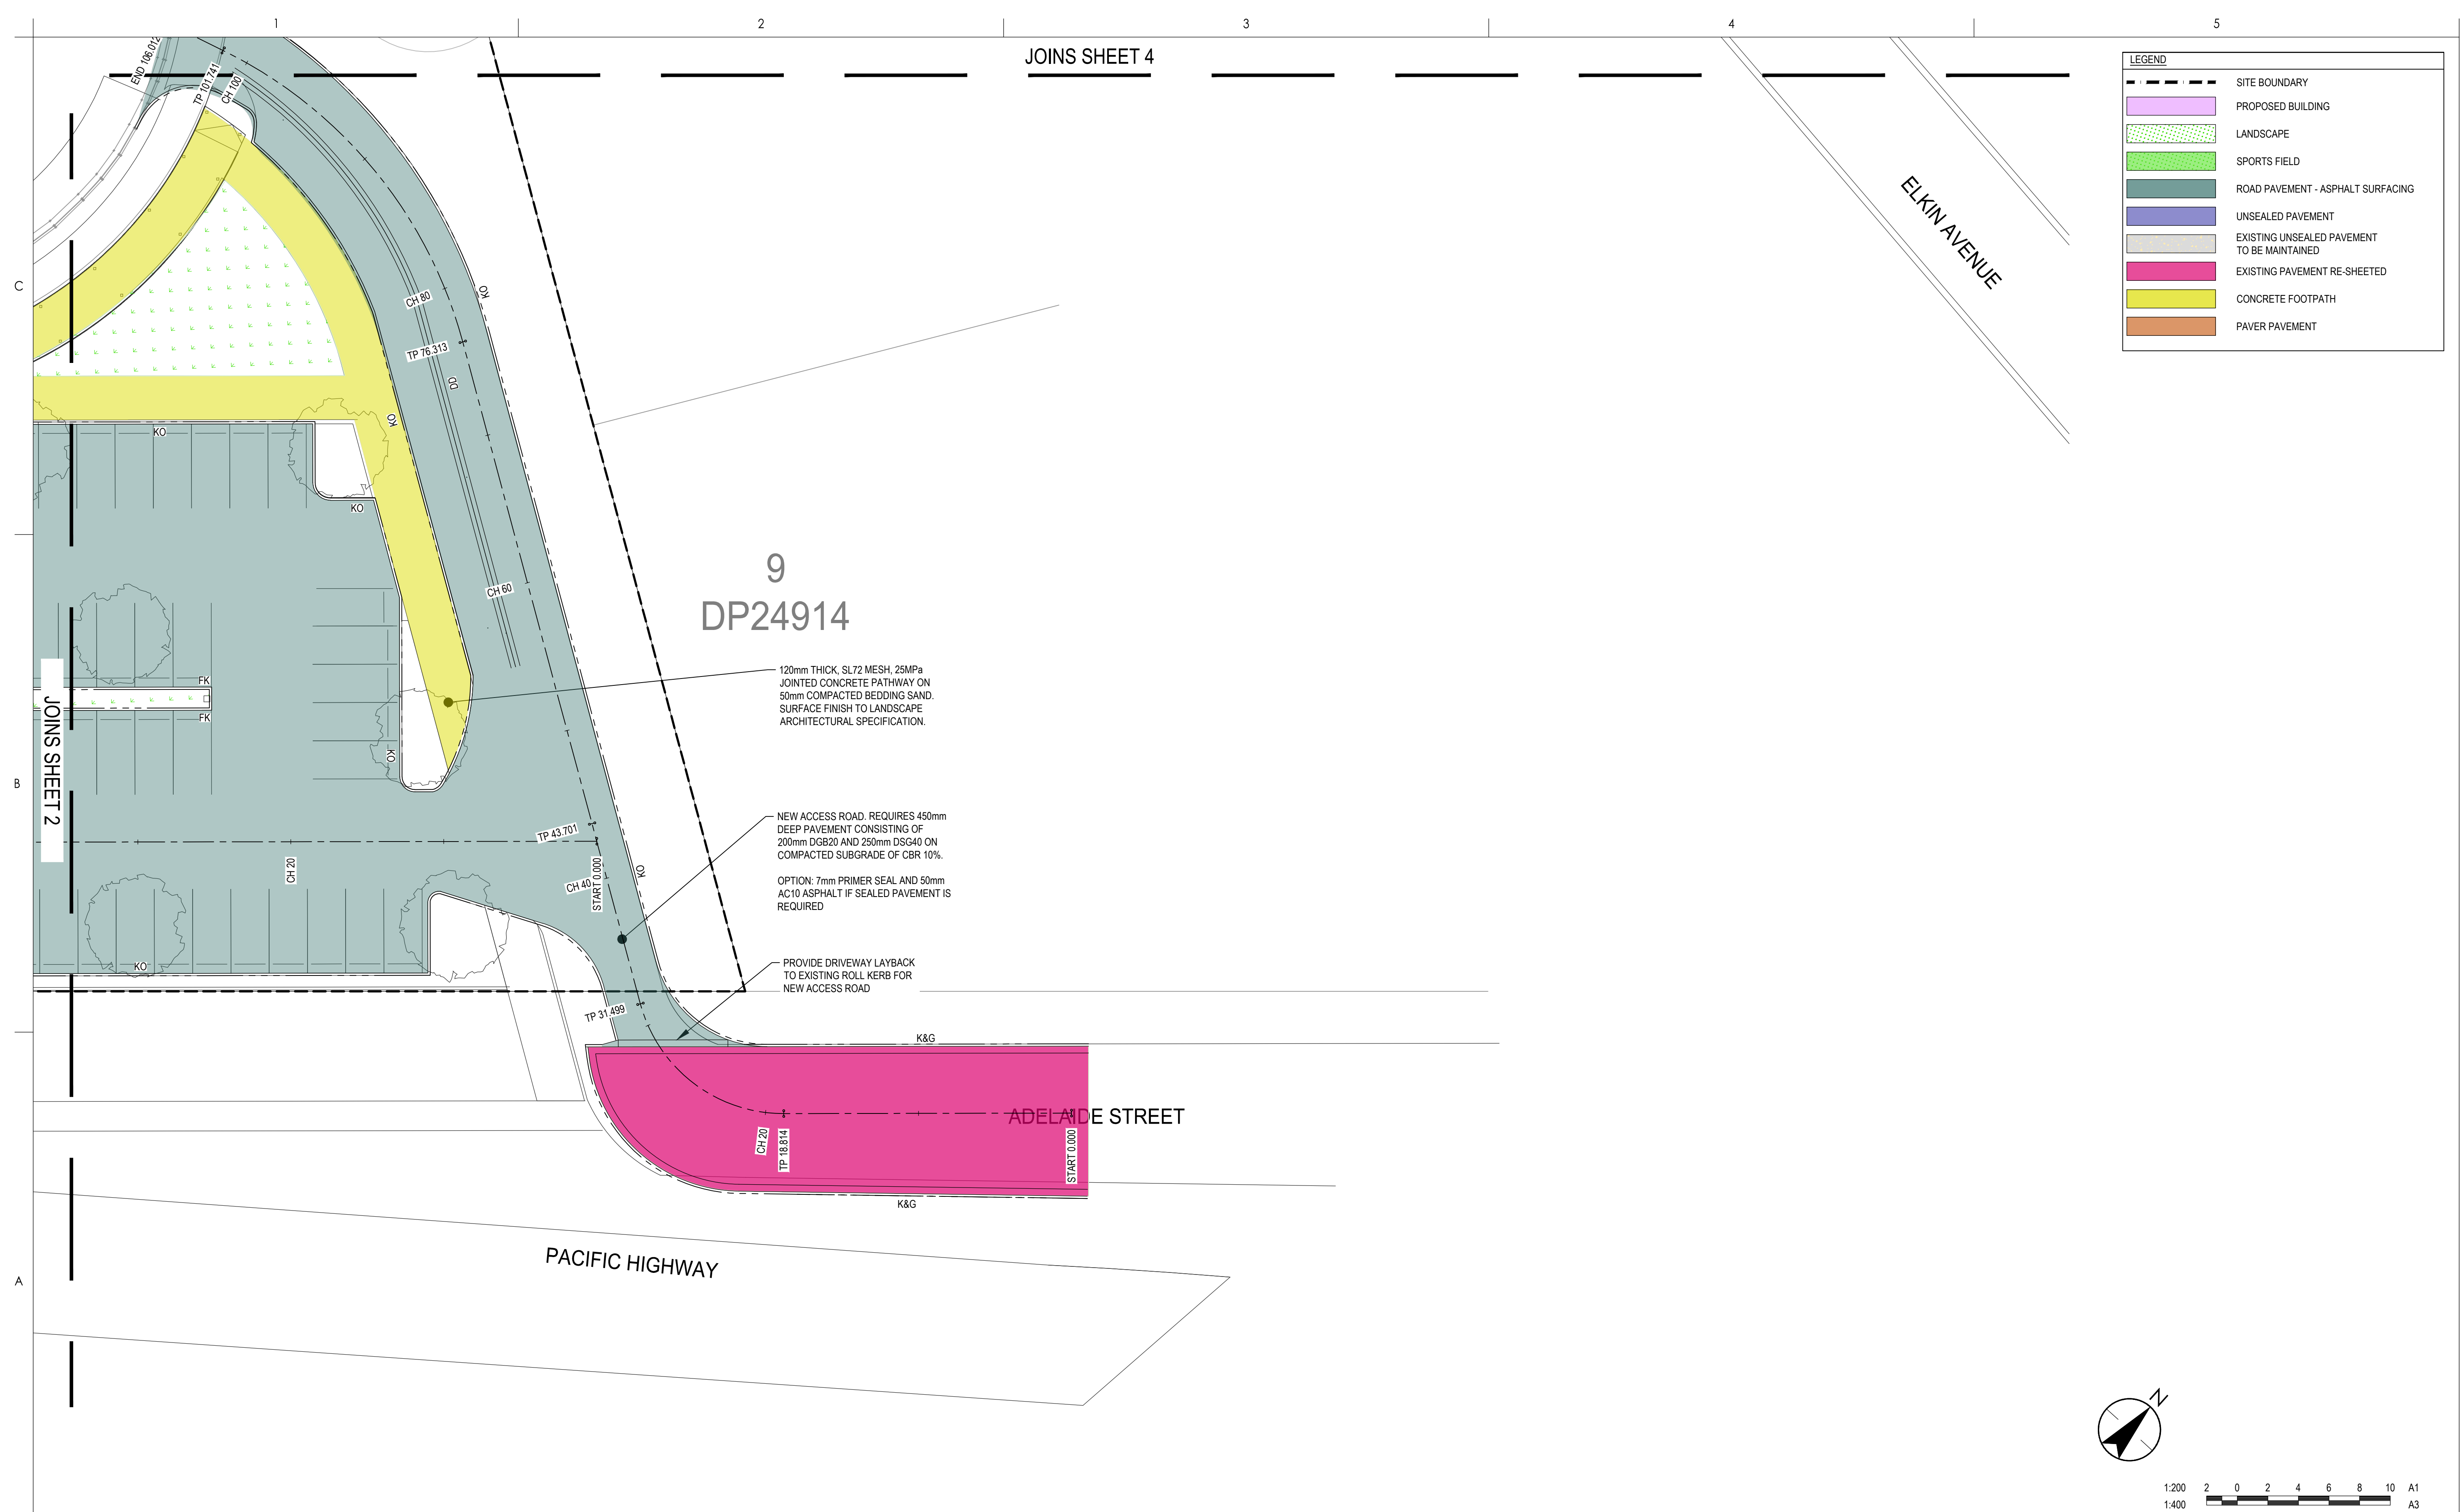

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Client/Project Logo



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	Dwn.	Dsgn.	Chkd.	YYYY.MM.DD

---

Title

PAVEMENT PLAN  
SHEET 1


Project No.

Revision  
**E**



o. Scale  
1:200

Drawing No.  
**HRHS-STNC-XX-XX-DR-C-440101**



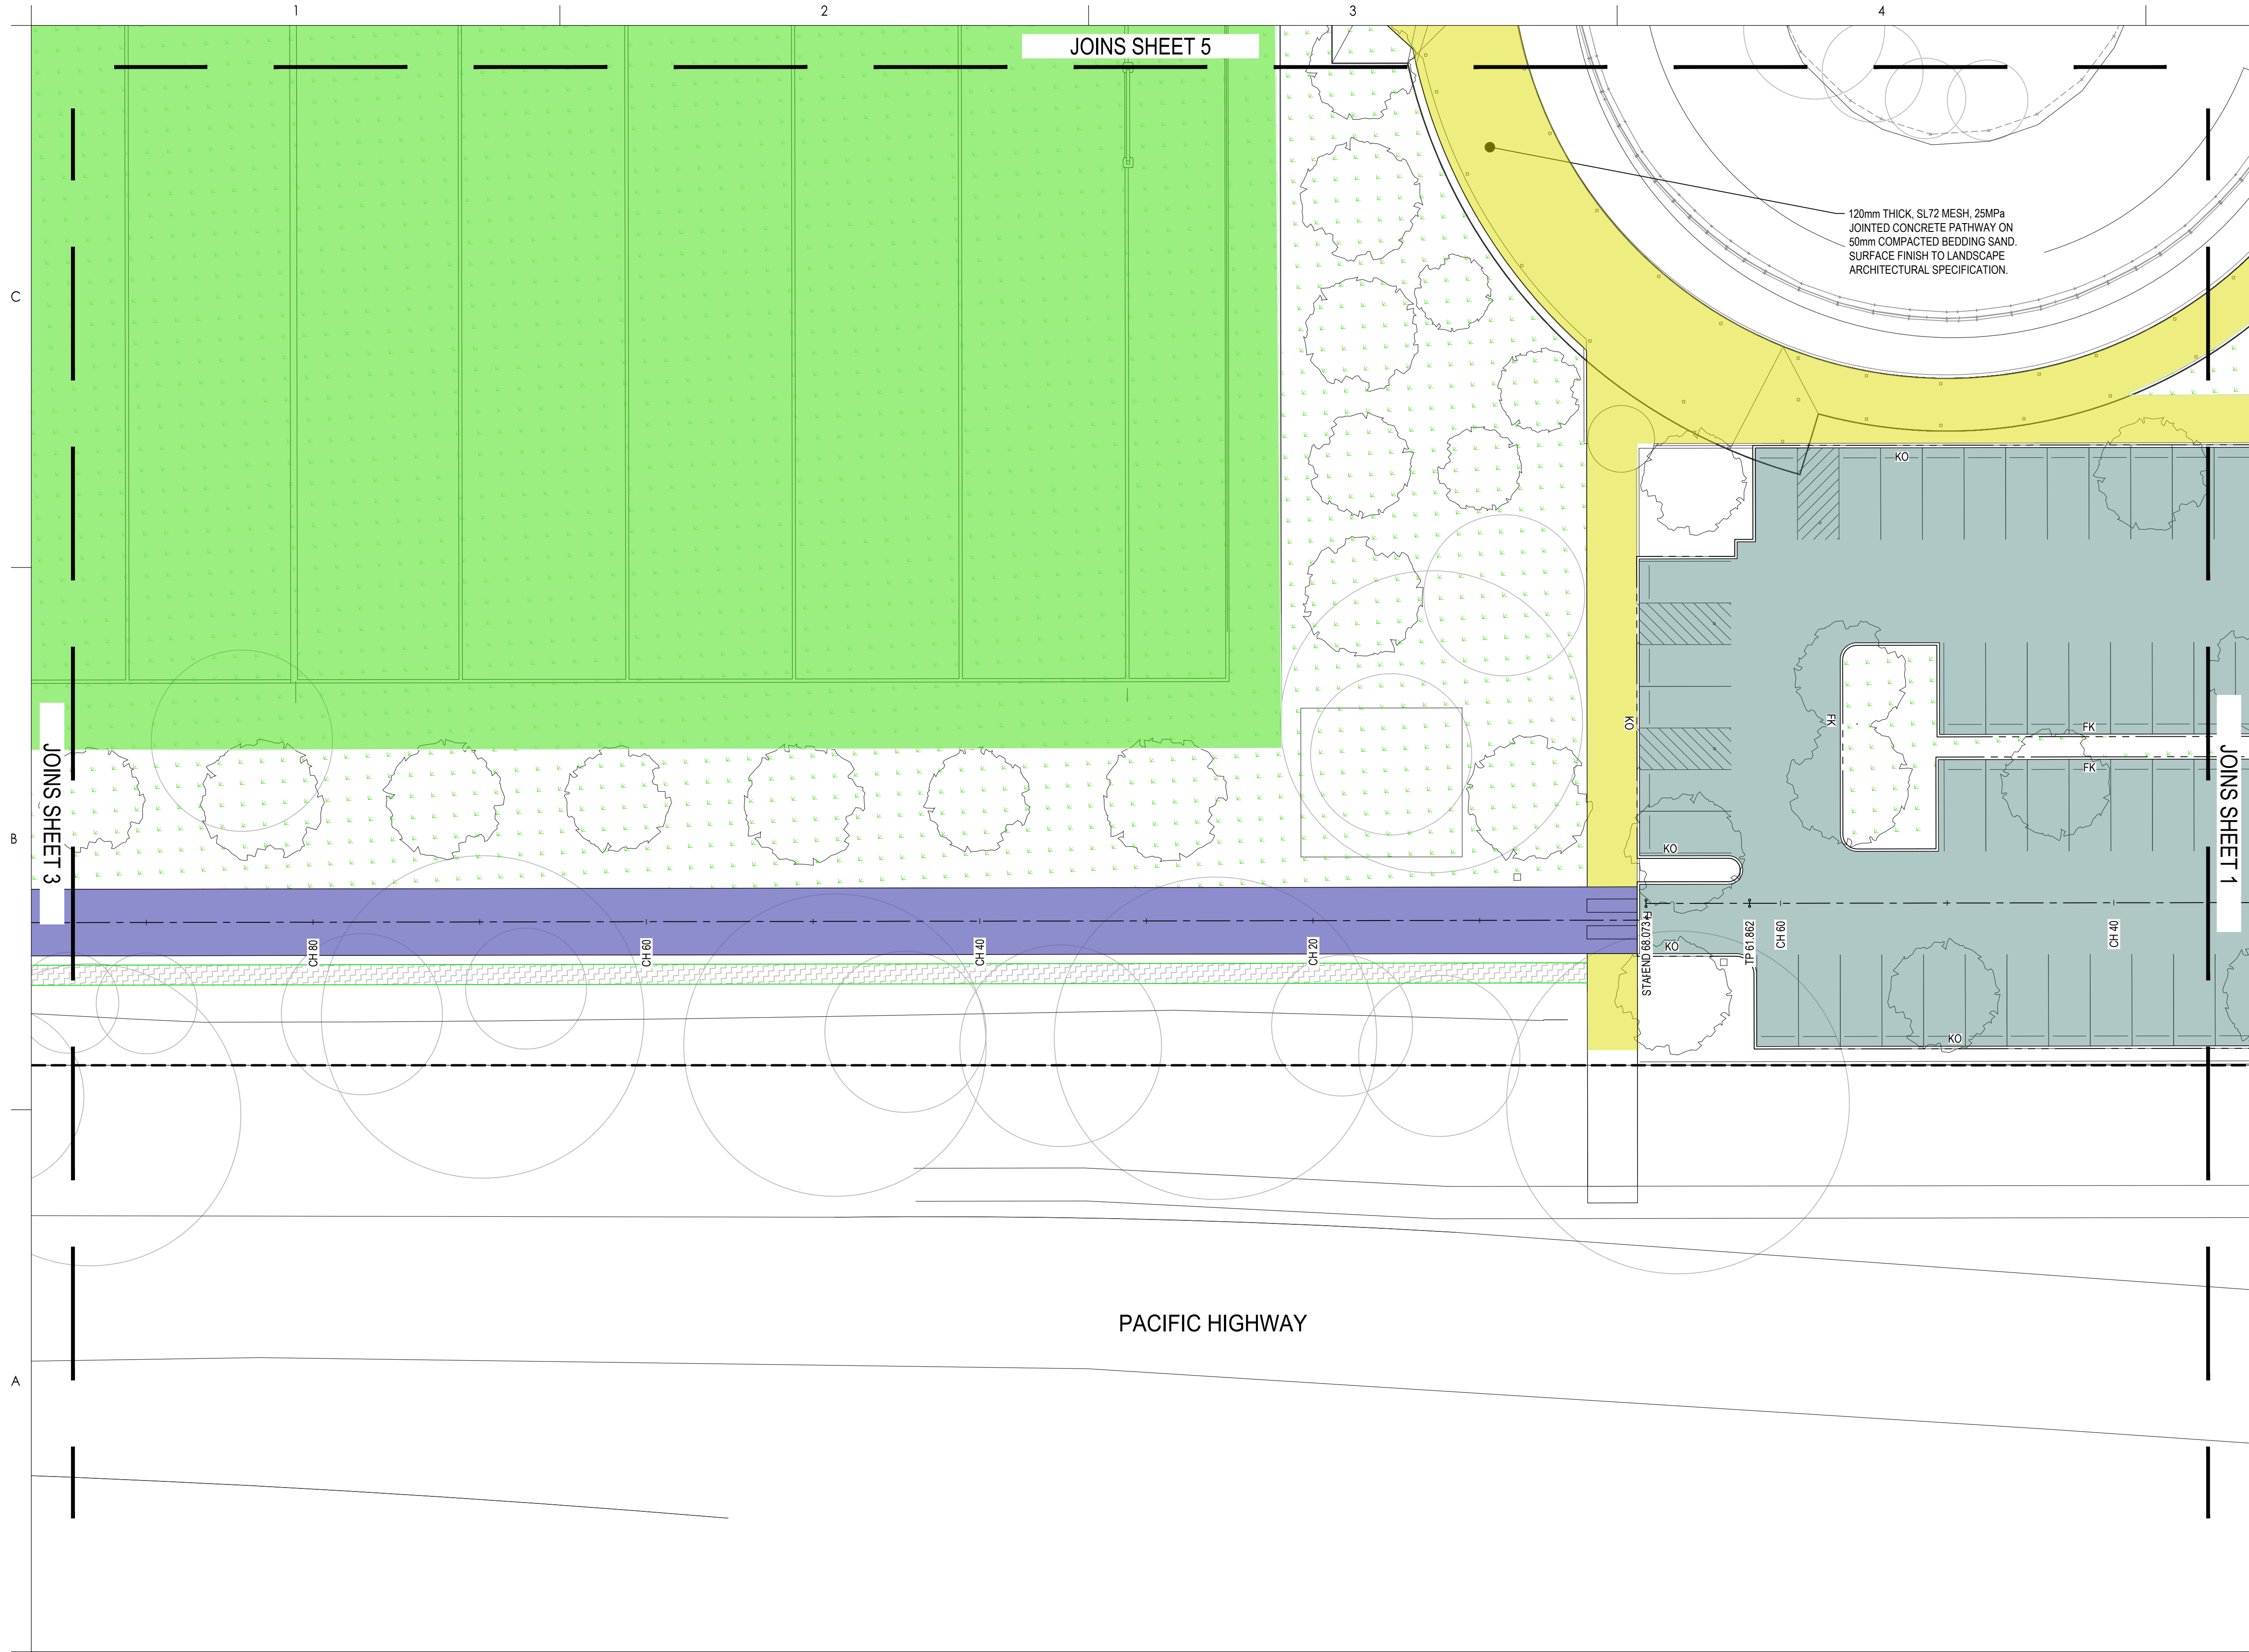

LEGEND	
	SITE BOUNDARY
	PROPOSED BUILDING
	LANDSCAPE
	SPORTS FIELD
	ROAD PAVEMENT - ASPHALT SURFACING
	UNSEALED PAVEMENT
	EXISTING UNSEALED PAVEMENT TO BE MAINTAINED
	EXISTING PAVEMENT RE-SHEETED
	CONCRETE FOOTPATH
	PAVER PAVEMENT

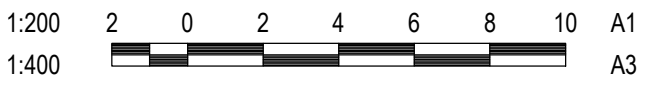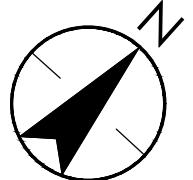

Notes

E	REVISED SCHEMATIC DESIGN	BCH	JMB	2023.09.01
D	REVISED SCHEMATIC DESIGN	CPO	JMB	2023.04.13
C	DRAFT REVISED SCHEMATIC DESIGN ISSUE	CPO	JMB	2023.03.24
B	FINAL PHASE 3 ISSUE	CPO	JMB	2022.08.08
A	100% SCHEMATIC DESIGN PROCESS	CPO	JMB	2022.07.29

Issued/Revision

By

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Client/Project

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HEATHERBRAE NSW 2324

File Name: HRHS-STNC-XX-XX-DR-C-440101.DWG

CPO	JMB	JMB	2022.07.29
Dwn.	Dign.	Chkd.	YYYY.MM.DD

Title

PAVEMENT PLAN SHEET 2

Project No.

Scale

1:200

Revision


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Drawing No.



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Plotted: 01:56:02 23/09/2023 12:04 PM By: HCONTI\_BEN  
UNPLOTED PROJECT DOCUMENTATION (DRAWINGS & DESIGN) VRS (SHEET SET)





LEGEND	
	SITE BOUNDARY
	PROPOSED BUILDING
	LANDSCAPE
	SPORTS FIELD
	ROAD PAVEMENT - ASPHALT SURFACING
	UNSEALED PAVEMENT
	EXISTING UNSEALED PAVEMENT TO BE MAINTAINED
	EXISTING PAVEMENT RE-SHEETED
	CONCRETE FOOTPATH
	PAVER PAVEMENT

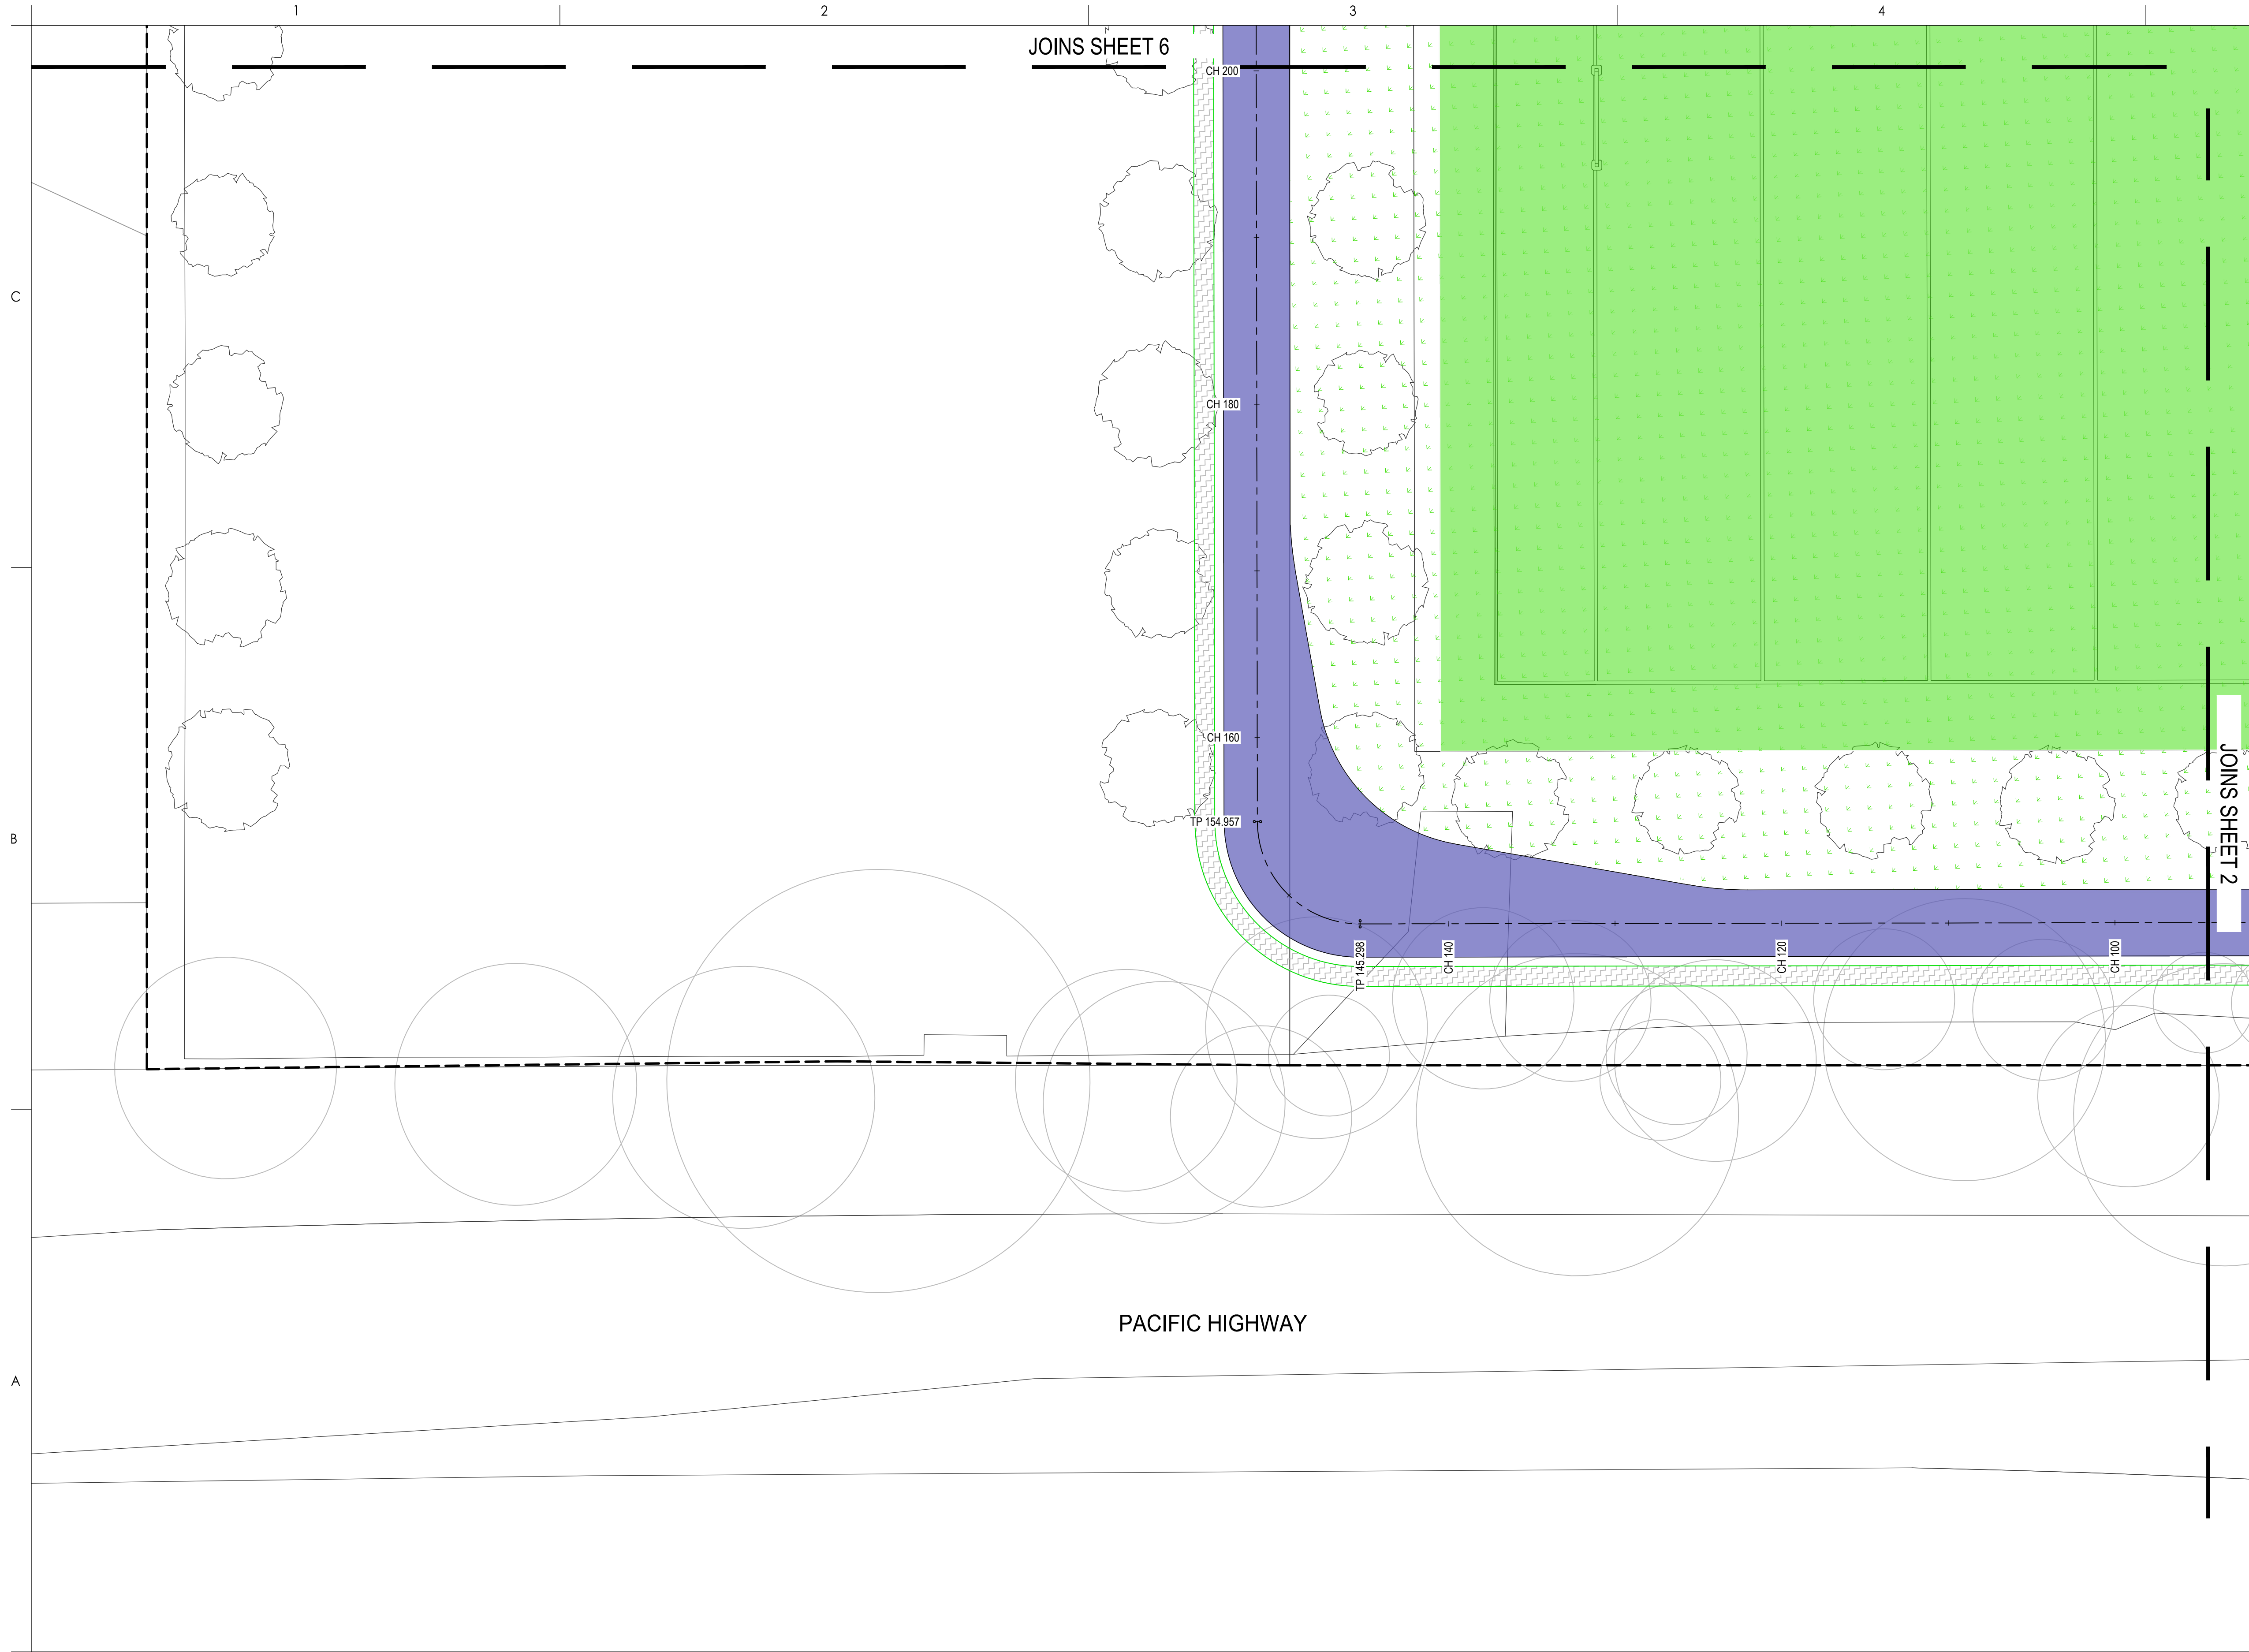

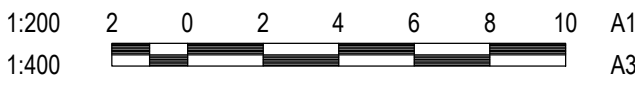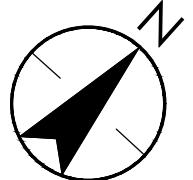Notes

E	REVISED SCHEMATIC DESIGN	BCH	JMB	2023.09.01
D	REVISED SCHEMATIC DESIGN	CPO	JMB	2023.04.13
C	DRAFT REVISED SCHEMATIC DESIGN ISSUE	CPO	JMB	2023.03.24
B	FINAL PHASE 3 ISSUE	CPO	JMB	2022.08.08
A	100% SCHEMATIC DESIGN PROCESS	CPO	JMB	2022.07.29

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Client/Project

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HEATHERBRAE NSW 2324

File Name: HRHS-STNC-XX-XX-DR-C-440101.DWG

CPO

JMB

JMB

2022.07.29

Dwn.

Dign.

Chkd.

YYYY.MM.DD

Title

PAVEMENT PLAN SHEET 3

Project No.

Scale

1:200

Revision

E

Drawing No.

HRHS-STNC-XX-XX-DR-C-440103

Plotted: 01/09/2023 2:45:22 PM By: HUNTER, BEN  
UN30130709 PROJECT DOCUMENTATION DRAWINGS & DESIGN VIEWS SHEET SET
















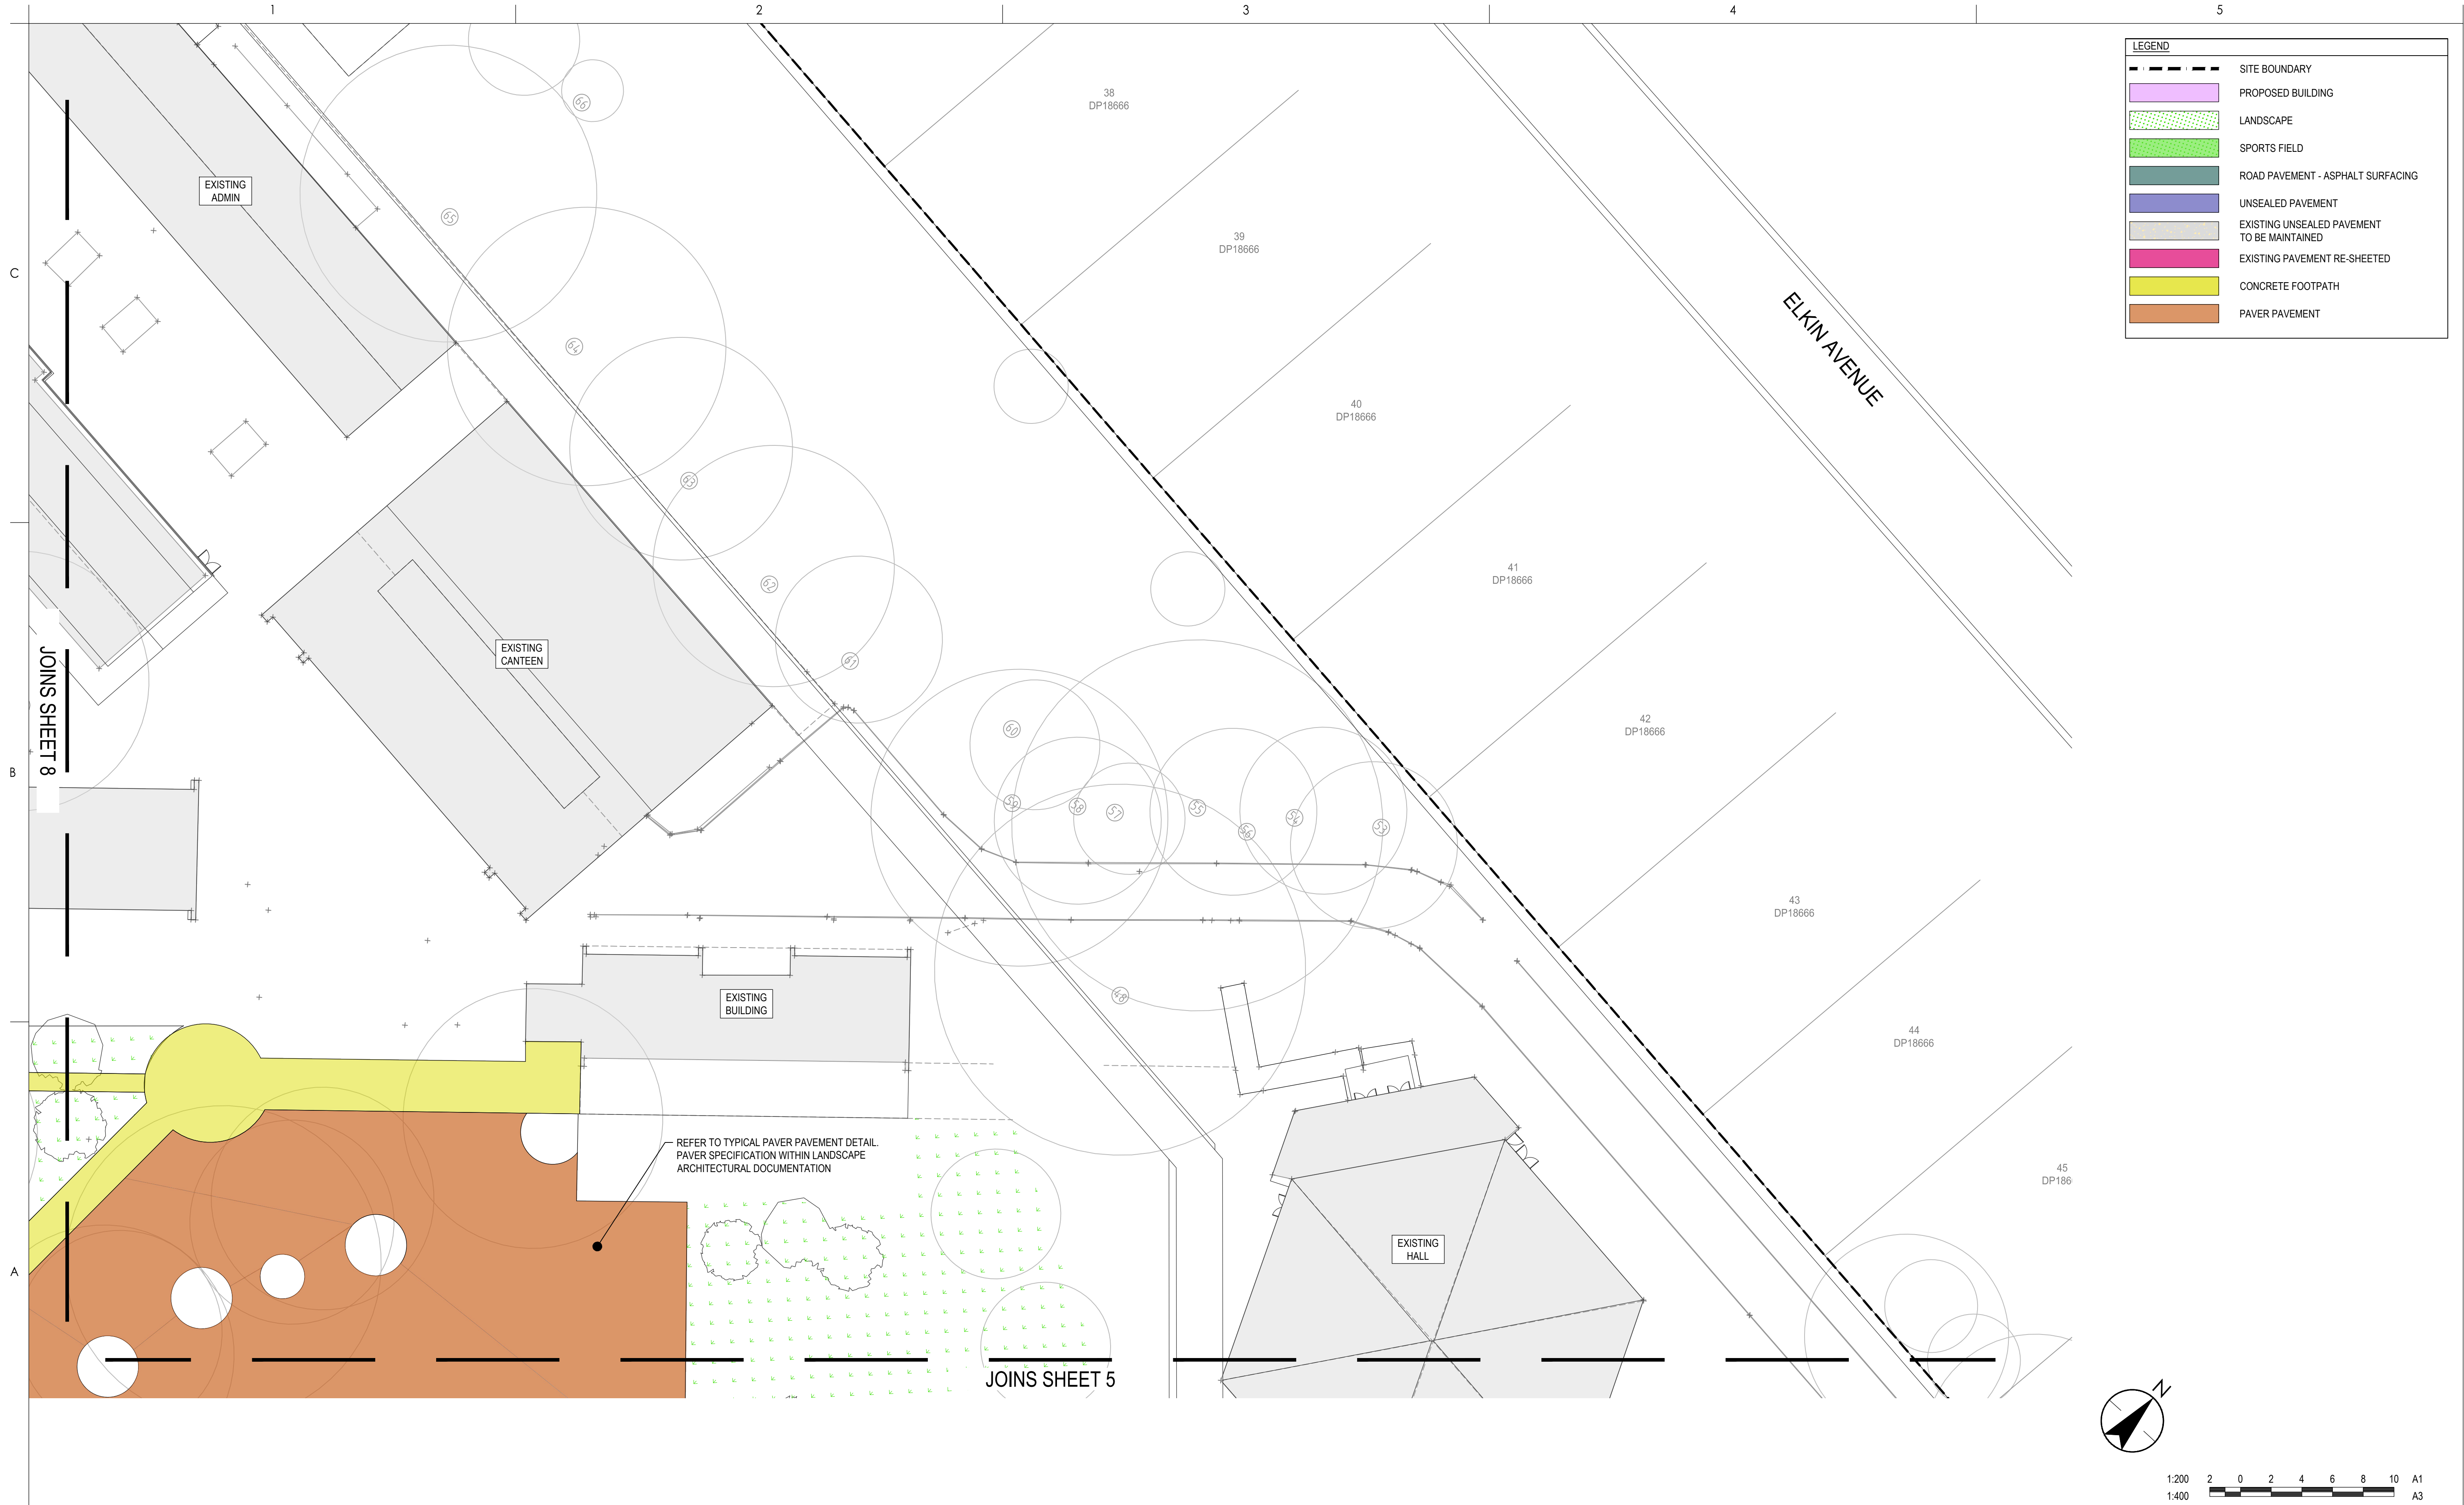

Notes

E	REVISED SCHEMATIC DESIGN	BCH	JMB	2023.09.01
D	REVISED SCHEMATIC DESIGN	CPO	JMB	2023.04.13
C	DRAFT REVISED SCHEMATIC DESIGN ISSUE	CPO	JMB	2023.03.24
B	FINAL PHASE 3 ISSUE	CPO	JMB	2022.08.08
A	100% SCHEMATIC DESIGN PROCESS	CPO	JMB	2022.07.29

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HEATHERBRAE NSW 2324

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CPO

JMB

JMB

2022.07.29

Dwn.

Dign.

Chkd.

YYYY.MM.DD

Title

PAVEMENT PLAN SHEET 7

Project No.

Scale

1:200

Revision

E

Drawing No.


HRHS-STNC-XX-XX-DR-C-440107

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UNCONTROLLED PROJECT DOCUMENTATION DRAWINGS & DESIGN VIEWS SHEET SET








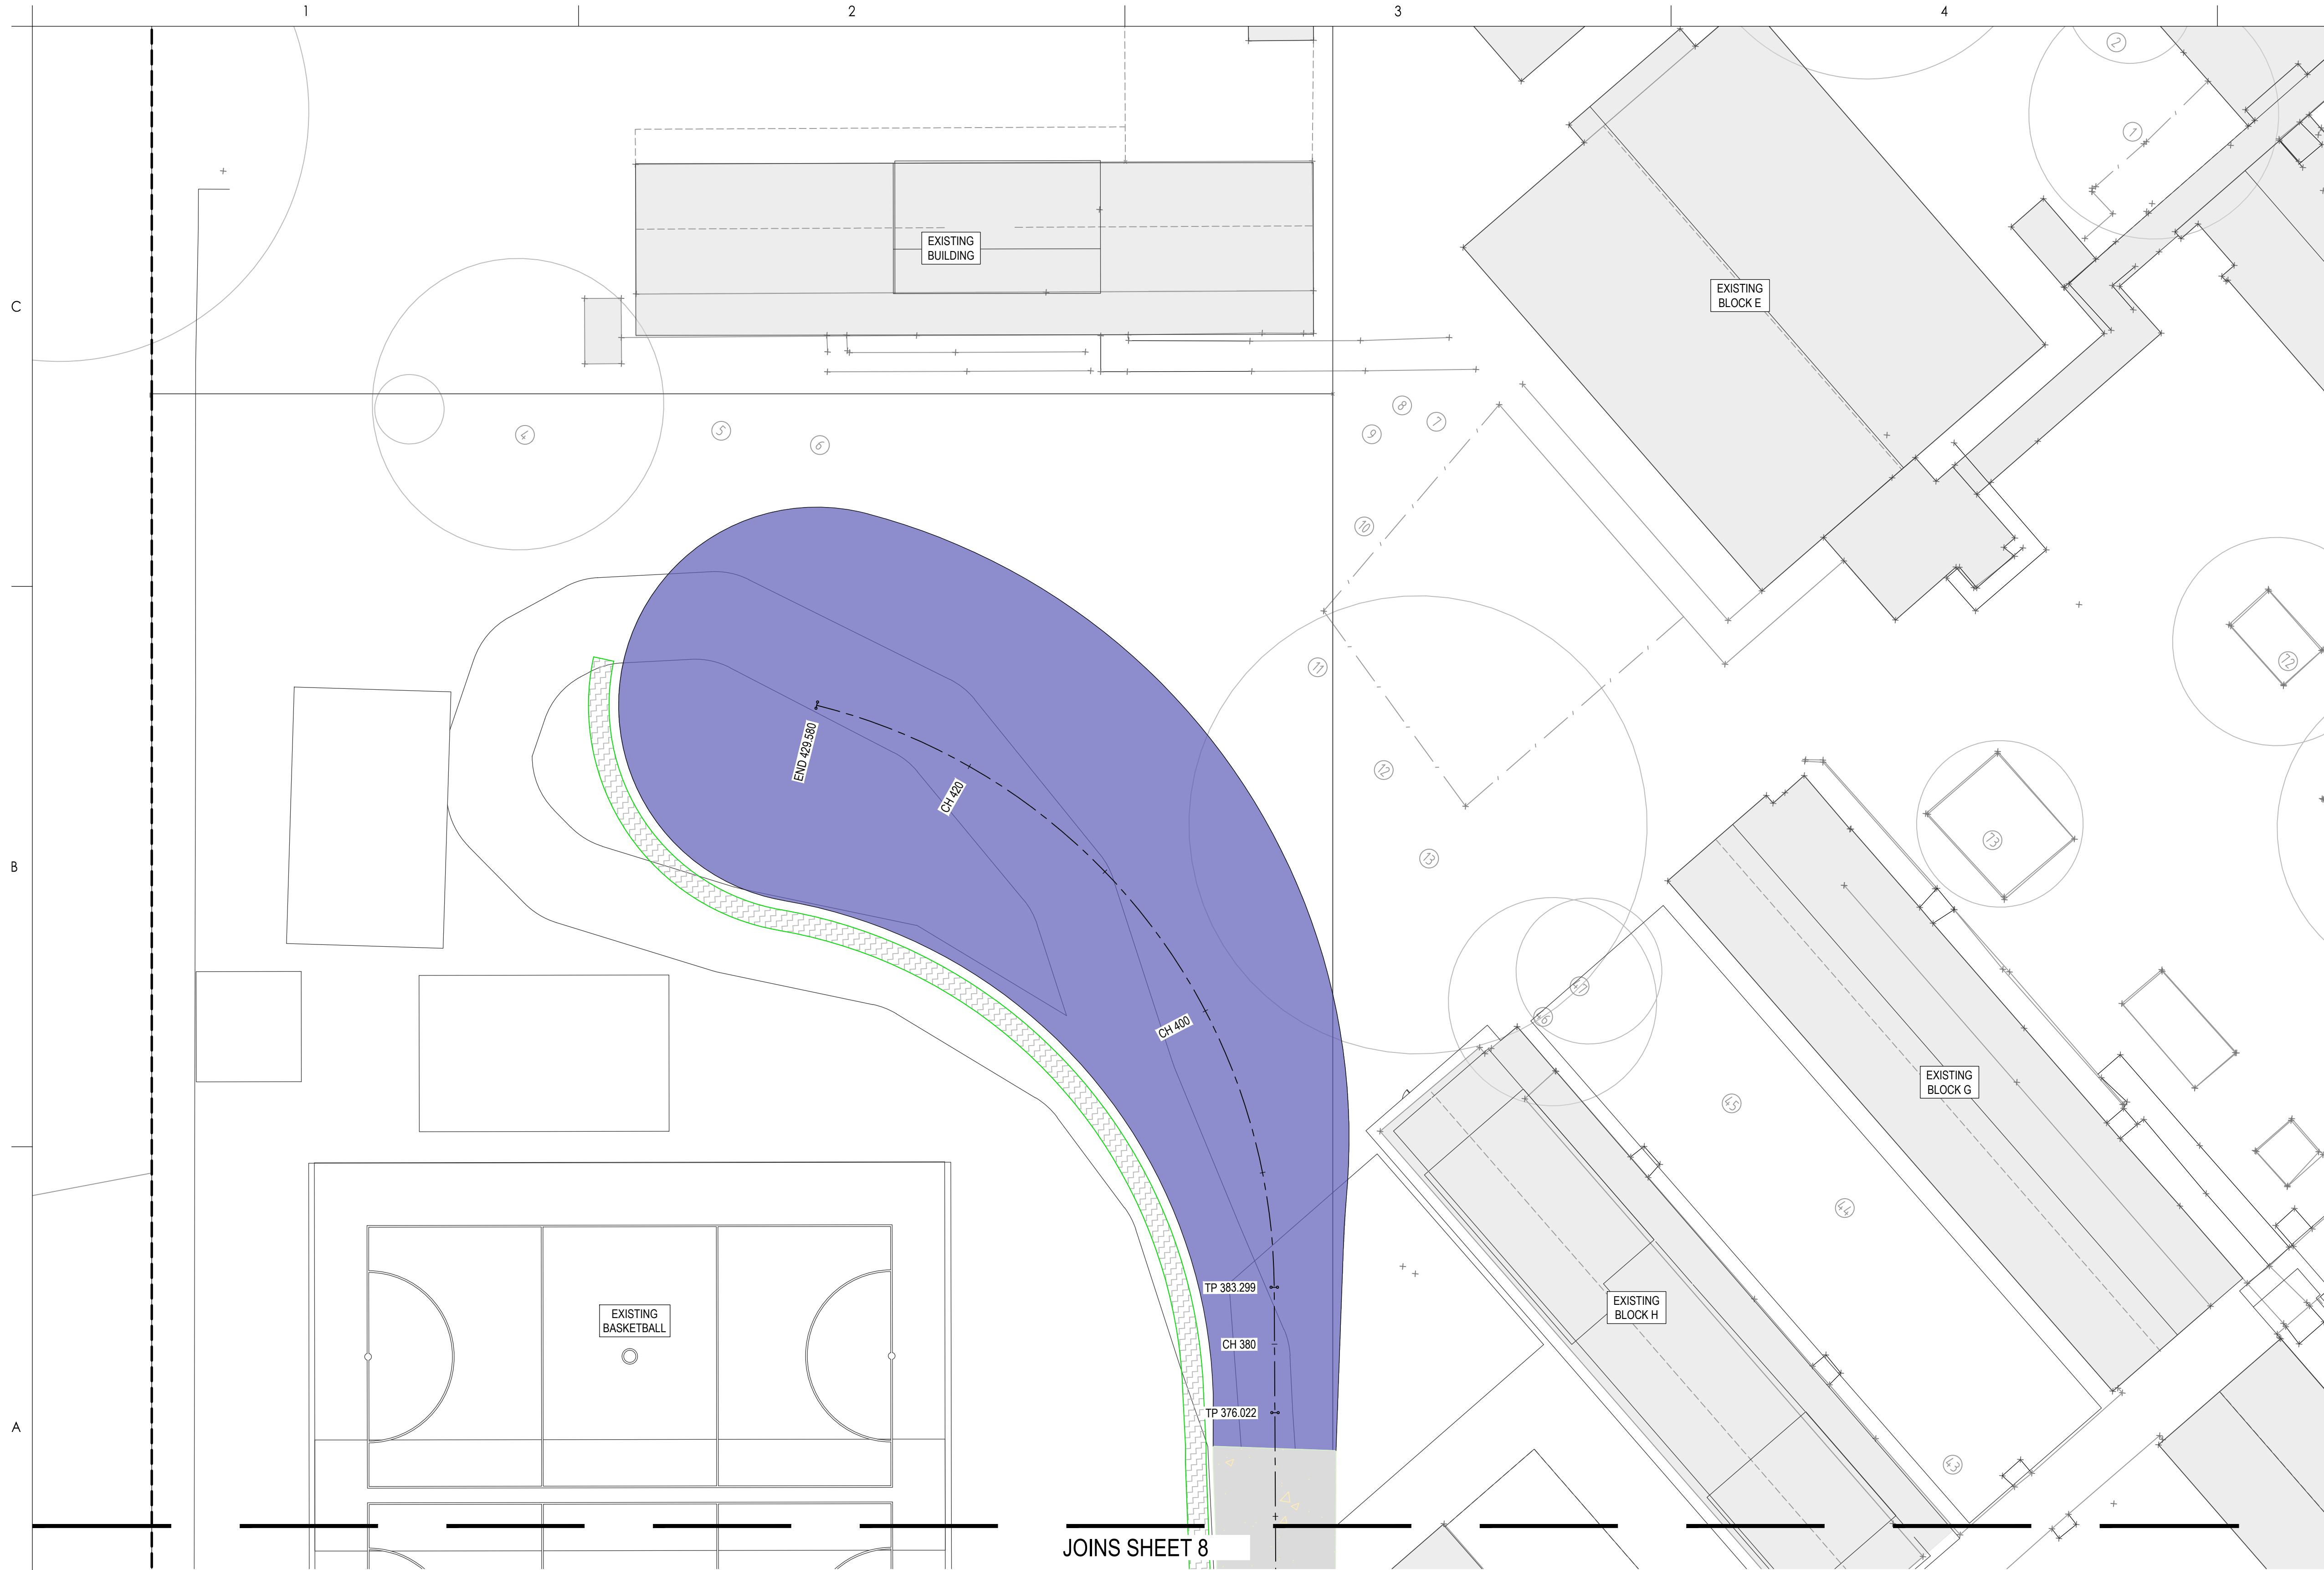

LEGEND	
	SITE BOUNDARY
	PROPOSED BUILDING
	LANDSCAPE
	SPORTS FIELD
	ROAD PAVEMENT - ASPHALT SURFACING
	UNSEALED PAVEMENT
	EXISTING UNSEALED PAVEMENT TO BE MAINTAINED
	EXISTING PAVEMENT RE-SHEETED
	CONCRETE FOOTPATH
	PAVER PAVEMENT

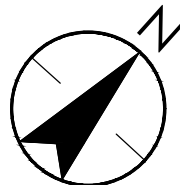

JOINS SHEET 8

Notes

E	REVISED SCHEMATIC DESIGN	BCH	JMB	2023.09.01
D	REVISED SCHEMATIC DESIGN	CPO	JMB	2023.04.13
C	DRAFT REVISED SCHEMATIC DESIGN ISSUE	CPO	JMB	2023.03.24
B	FINAL PHASE 3 ISSUE	CPO	JMB	2022.08.08
A	100% SCHEMATIC DESIGN PROCESS	CPO	JMB	2022.07.29

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Client/Project Logo

Client/Project

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HEATHERBRAE NSW 2324

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CPO	JMB	JMB	2022.07.29
Dwn.	Dign.	Chkd.	YYYY.MM.DD

Title

PAVEMENT PLAN SHEET 9

Project No.


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Revision E



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
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UN30130709 PROJECT DOCUMENTATION DRAWINGS & DESIGN INFO SHEET SET






LEGEND	
	SITE BOUNDARY
	PROPOSED BUILDING
	LANDSCAPE
	SPORTS FIELD
	ROAD PAVEMENT - ASPHALT SURFACING
	UNSEALED PAVEMENT
	EXISTING UNSEALED PAVEMENT TO BE MAINTAINED
	EXISTING PAVEMENT RE-SHEETED
	CONCRETE FOOTPATH
	PAVER PAVEMENT

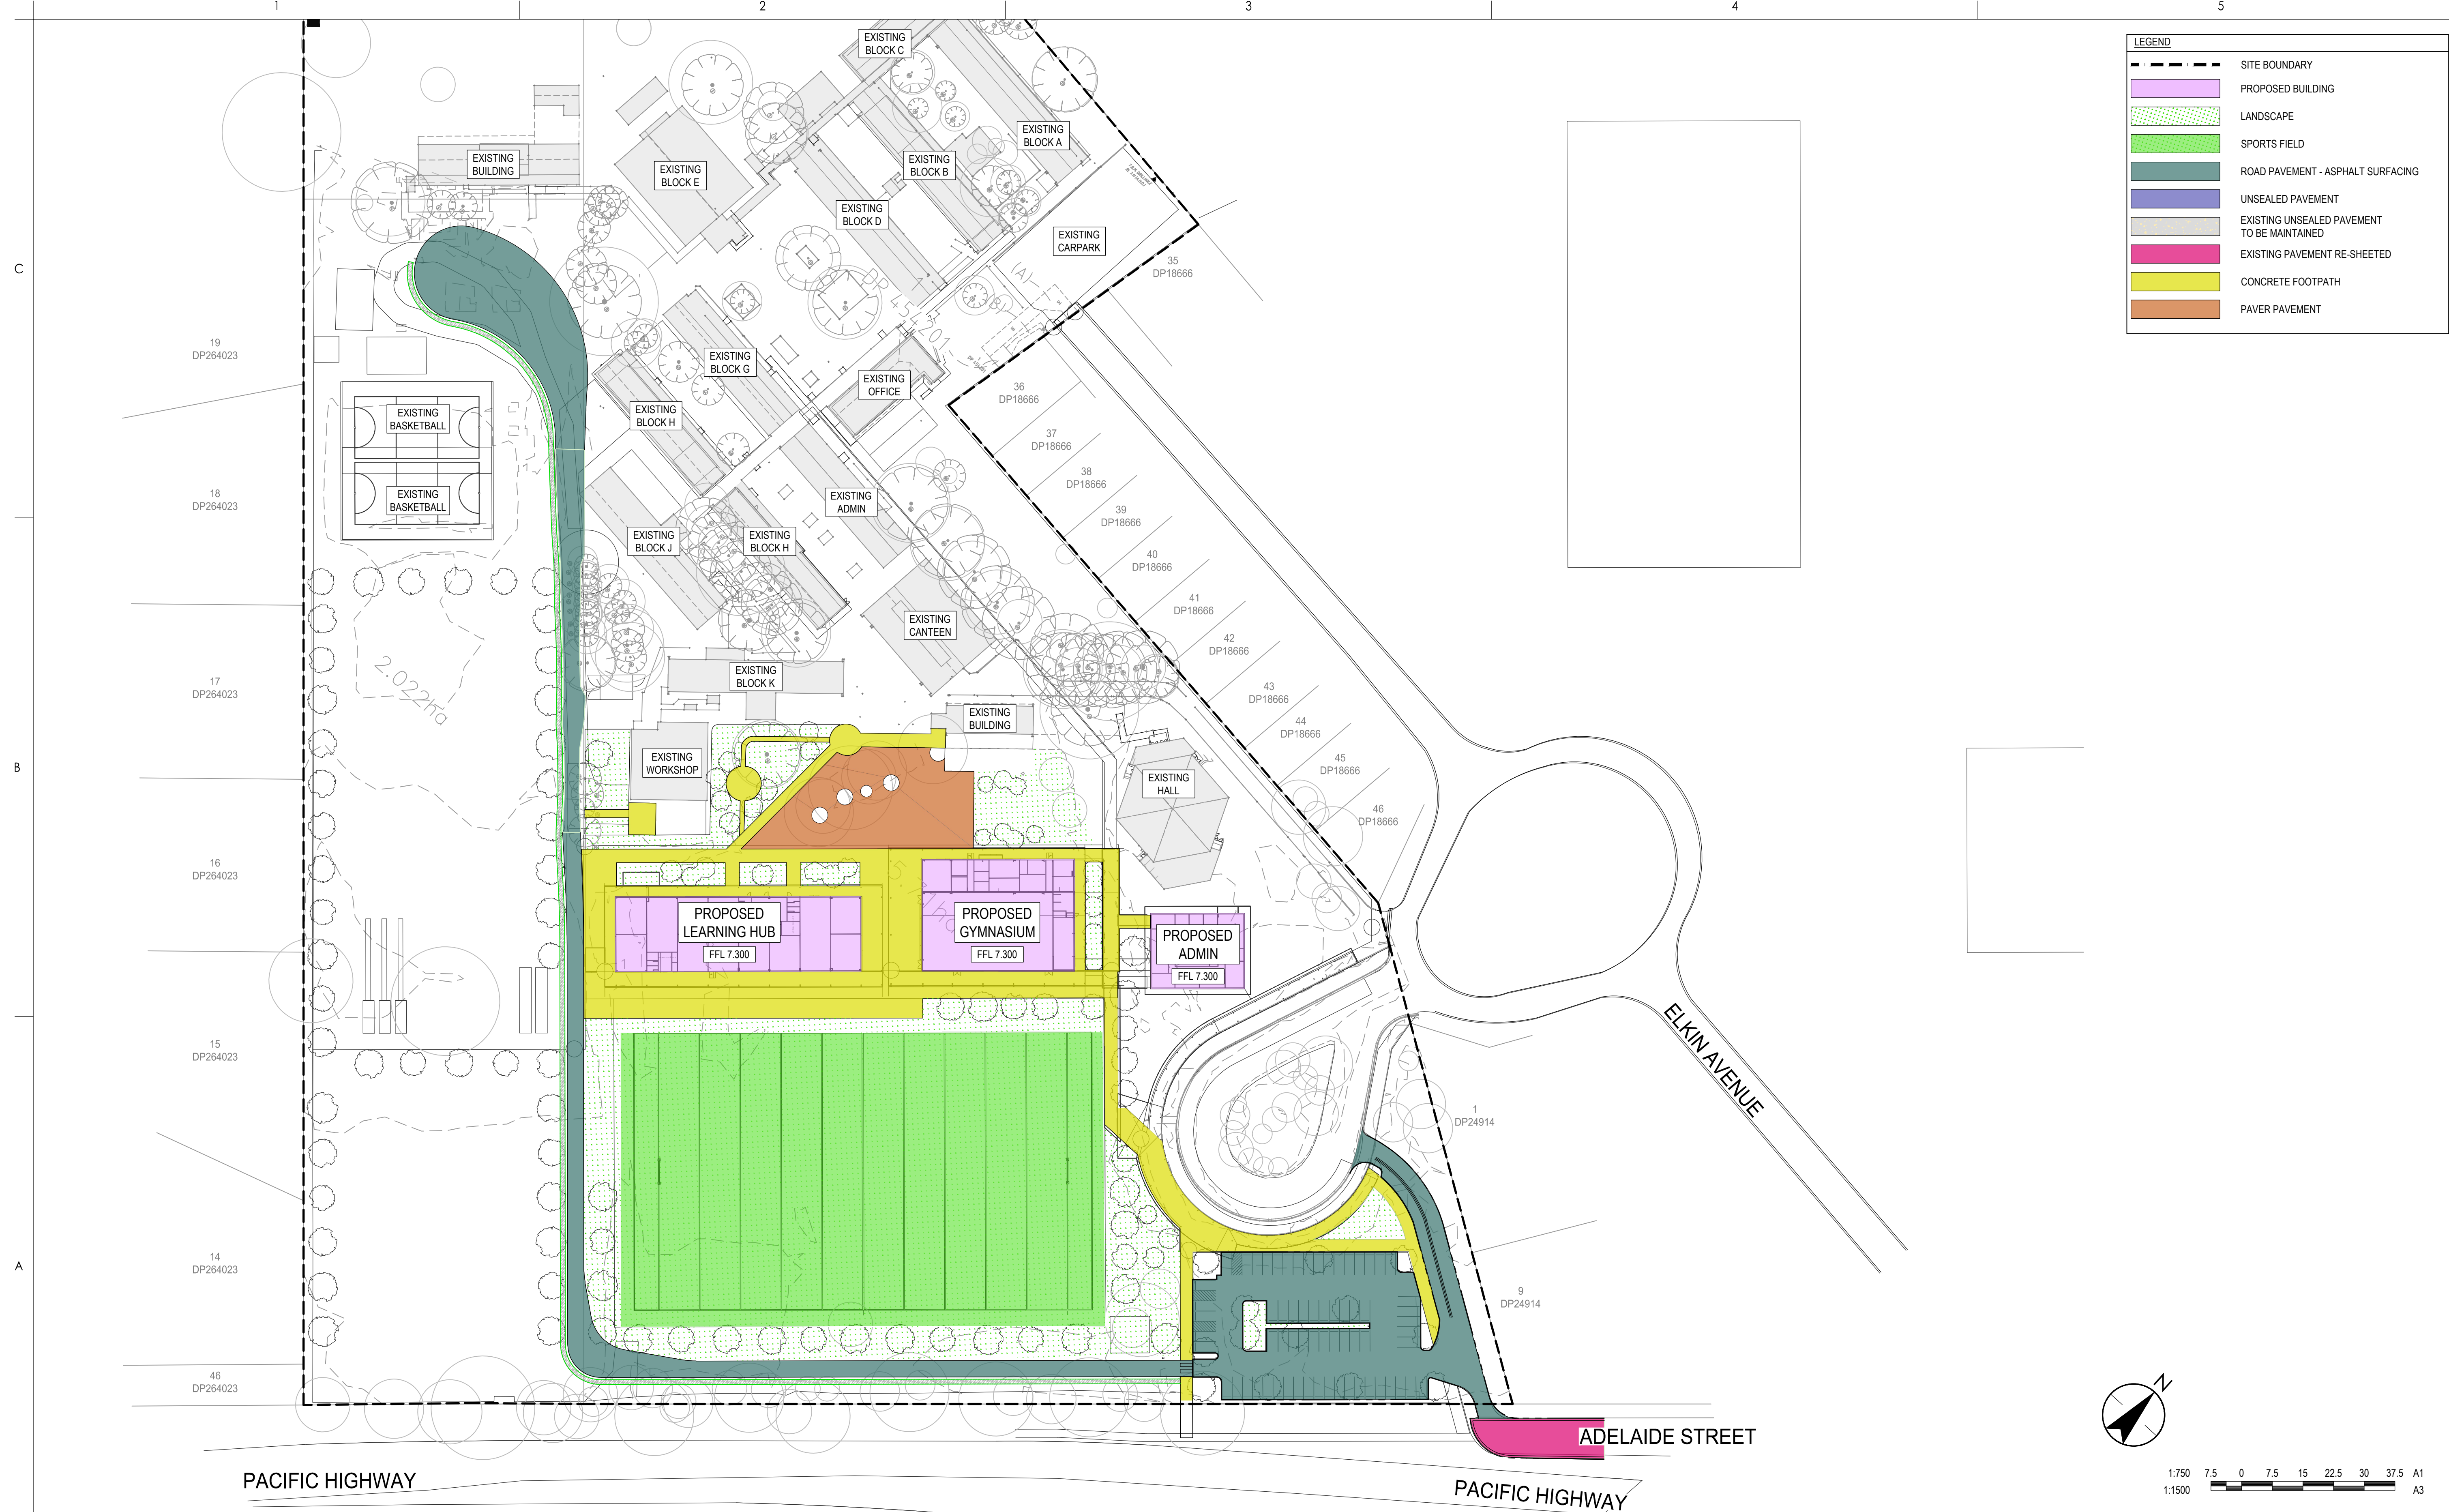
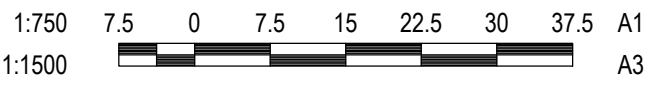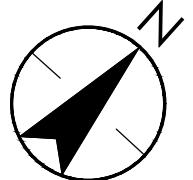
<div>Notes</div>		<div>Issue Status</div>		<div>Colour Disclaimer</div>		<div>Client/Project Logo</div>		<div>Client/Project</div>		<div>Title</div>	
				<div>This drawing has been documented in colour. This drawing is required to be printed in colour. Failure to do so may result in loss of information. Black and white printing may be used if specific black and white documents have been obtained from Stantec.</div>		<div></div>		<div>SINSW</div>		<div>ALTERNATE SEALED SERVICE ROAD PLAN</div>	
				<div>Notes</div>		<div>Stantec Australia Pty. Ltd. Level 6, Building B 207 Pacific Highway St Leonards, NSW 2045 Tel: +61 2 8484 7000</div>		<div>HUNTERS RIVER HIGH SCHOOL</div>		<div>Project No.</div>	
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				<div>The Copyrights to all designs and drawings are the property of Stantec. Reproduction or use for any purpose other than that authorized by Stantec is forbidden. The Contractor shall verify and be responsible for all dimensions. DO NOT scale the drawing - any errors or omissions shall be reported to Stantec without delay.</div>		<div>File Name: HRHS-STNC-XX-XX-DR-C-440200.DWG</div>		<div>CPO</div>		<div>1:750</div>	
								<div>JMB</div>		<div>JMB</div>	
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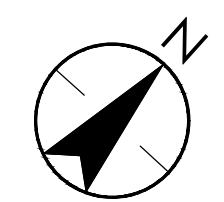


**LEGEND**

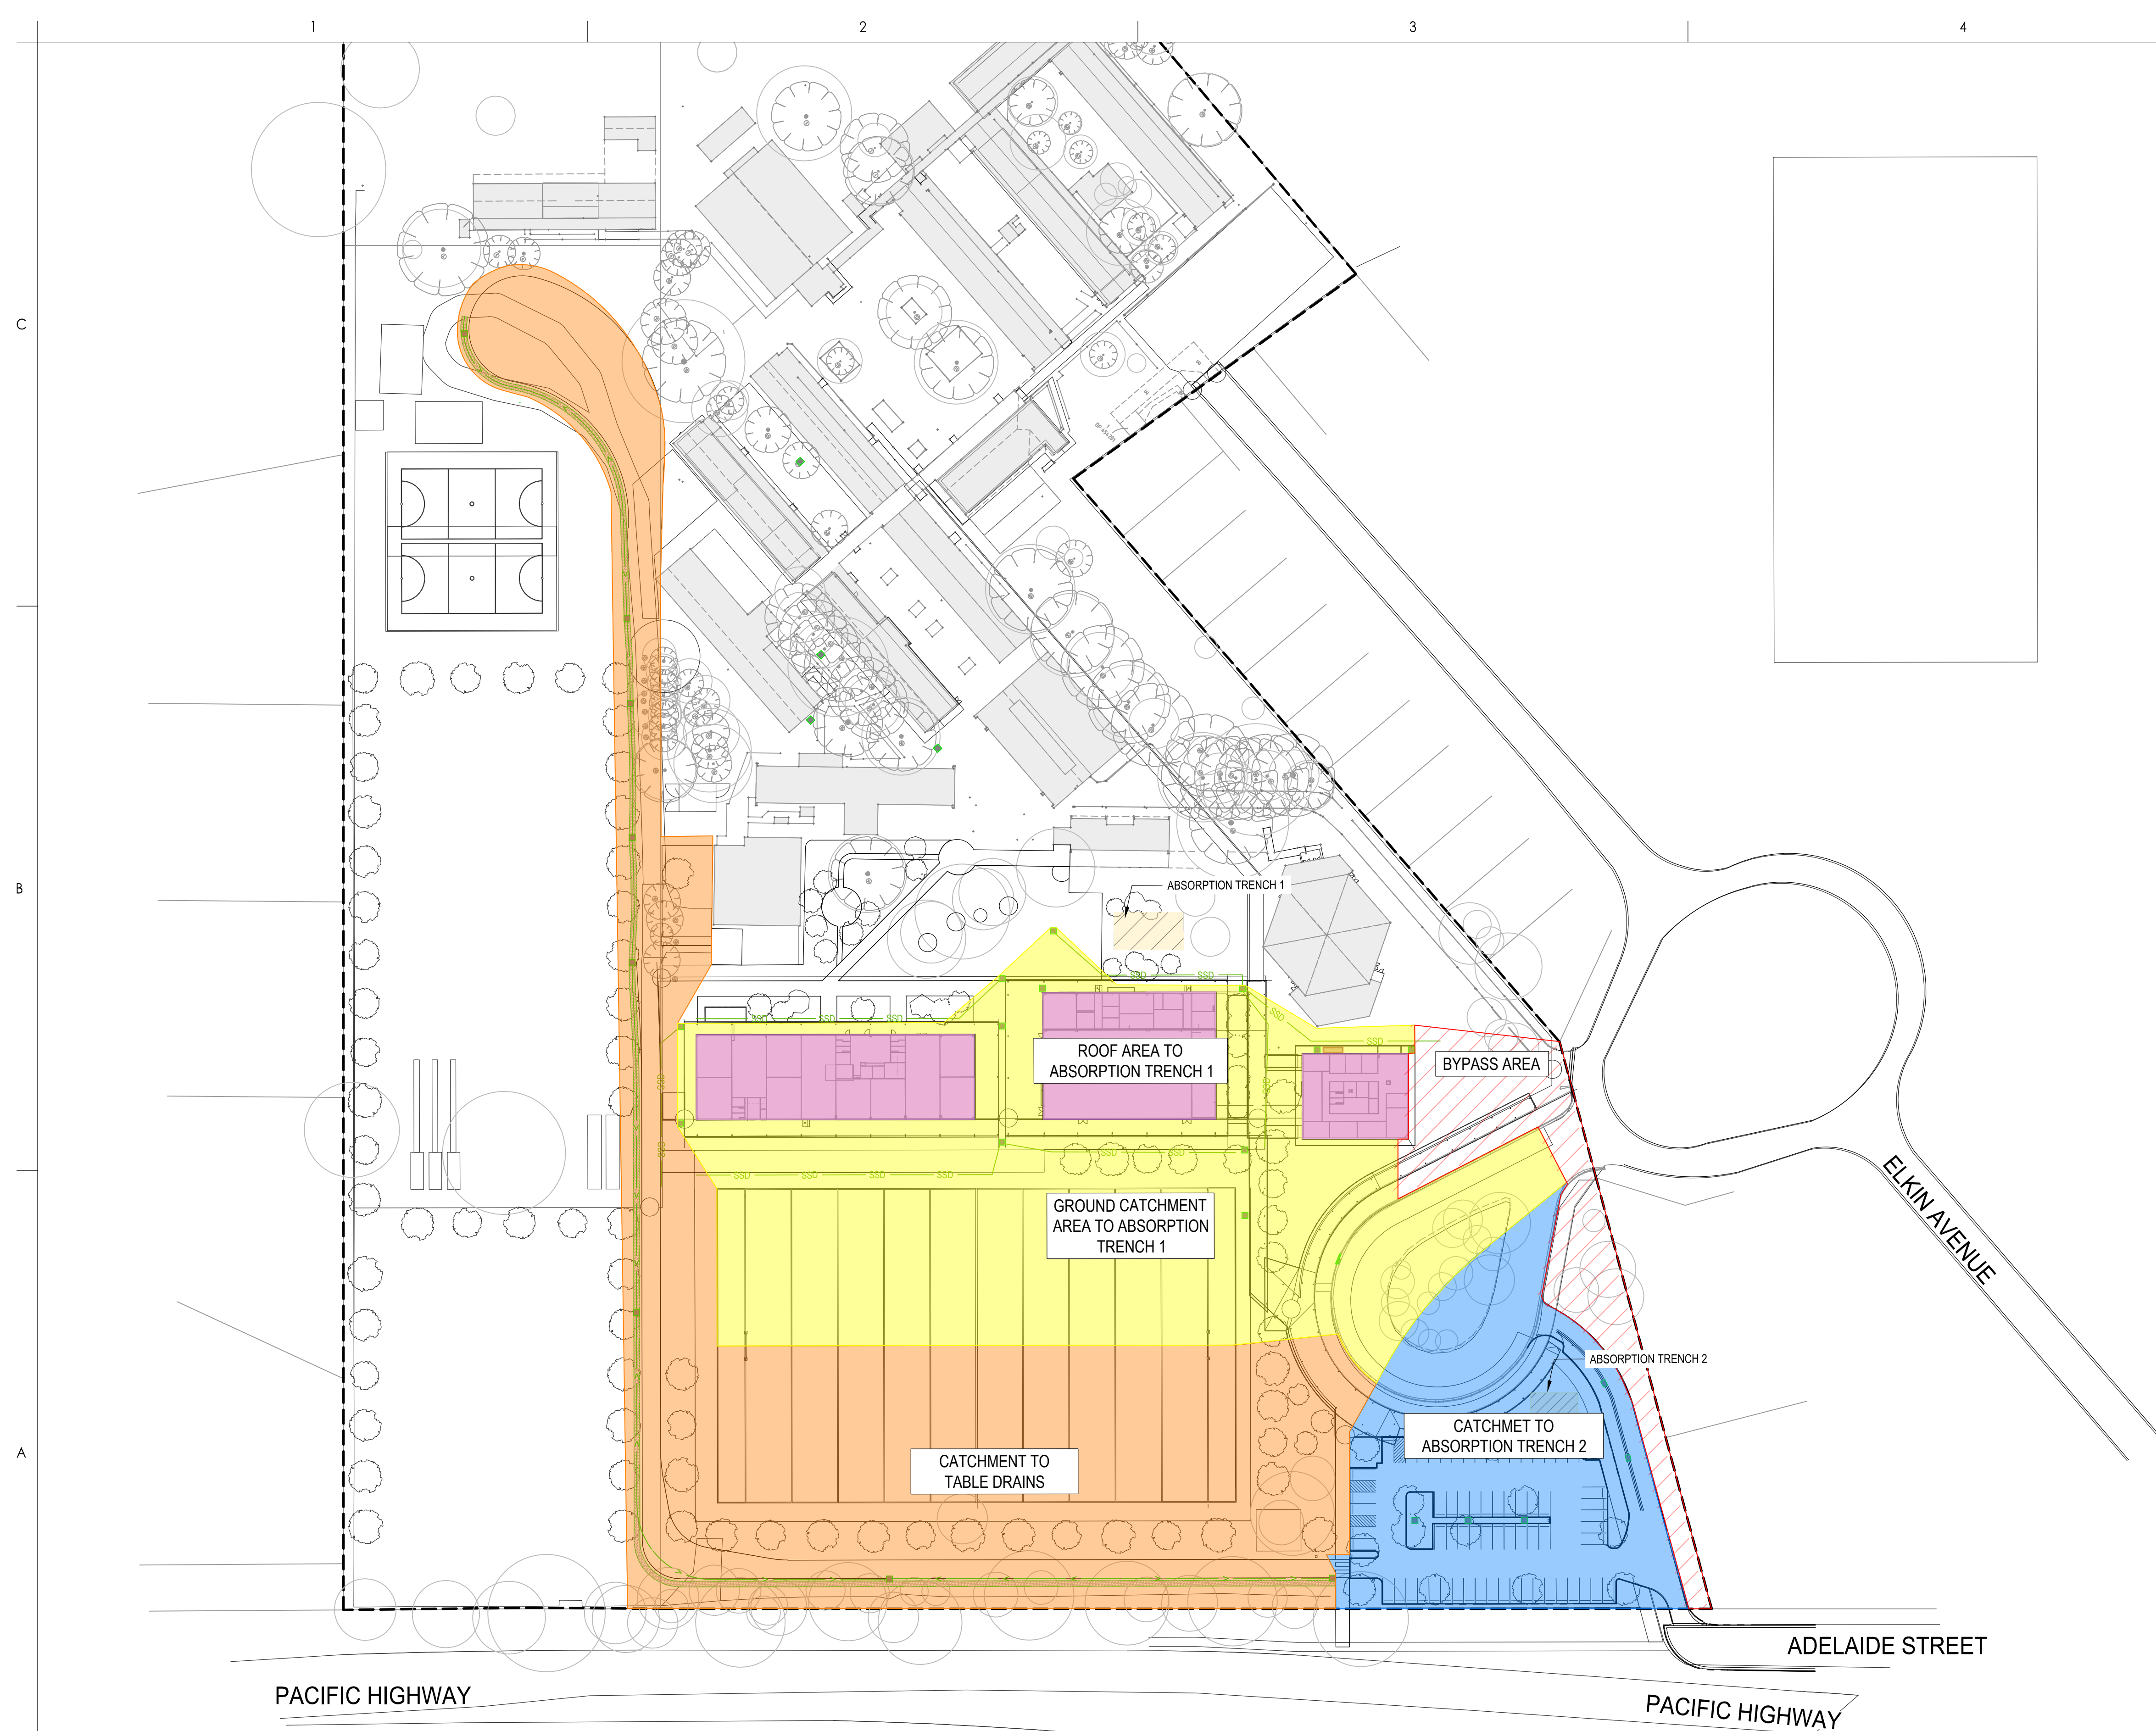
- SITE BOUNDARY (represented by a dashed line)
- PROPOSED BUILDING (represented by a solid black rectangle)
- CATCHMENT TO ABSORPTION TRENCH 1 (represented by a solid light blue rectangle)
- CATCHMENT TO ABSORPTION TRENCH 2 (represented by a solid light green rectangle)
- CATCHMENT TO TABLE DRAINS (represented by a solid light orange rectangle)
- BYPASS AREA (represented by a rectangle with diagonal hatching)

**CATCHMENT:**

- TOTAL SITE AREA = 94,217m<sup>2</sup>
- TOTAL AREA TO BE DEVELOPED = 31,029m<sup>2</sup>
- TOTAL CATCHMENT TO ABSORPTION TRENCH 1= 11,995m<sup>2</sup>
  - ROOF AREA = 2,577m<sup>2</sup>
  - GROUND AREA = 9,418m<sup>2</sup>
- TOTAL CATCHMENT TO ABSORPTION TRENCH 2 = 4,305m<sup>2</sup>
- TOTAL CATCHMENT TO TABLE DRAINS =12,927m<sup>2</sup>
- TOTAL BYPASS = 1,802m<sup>2</sup> (5.8% of total developed area)

[illegible]



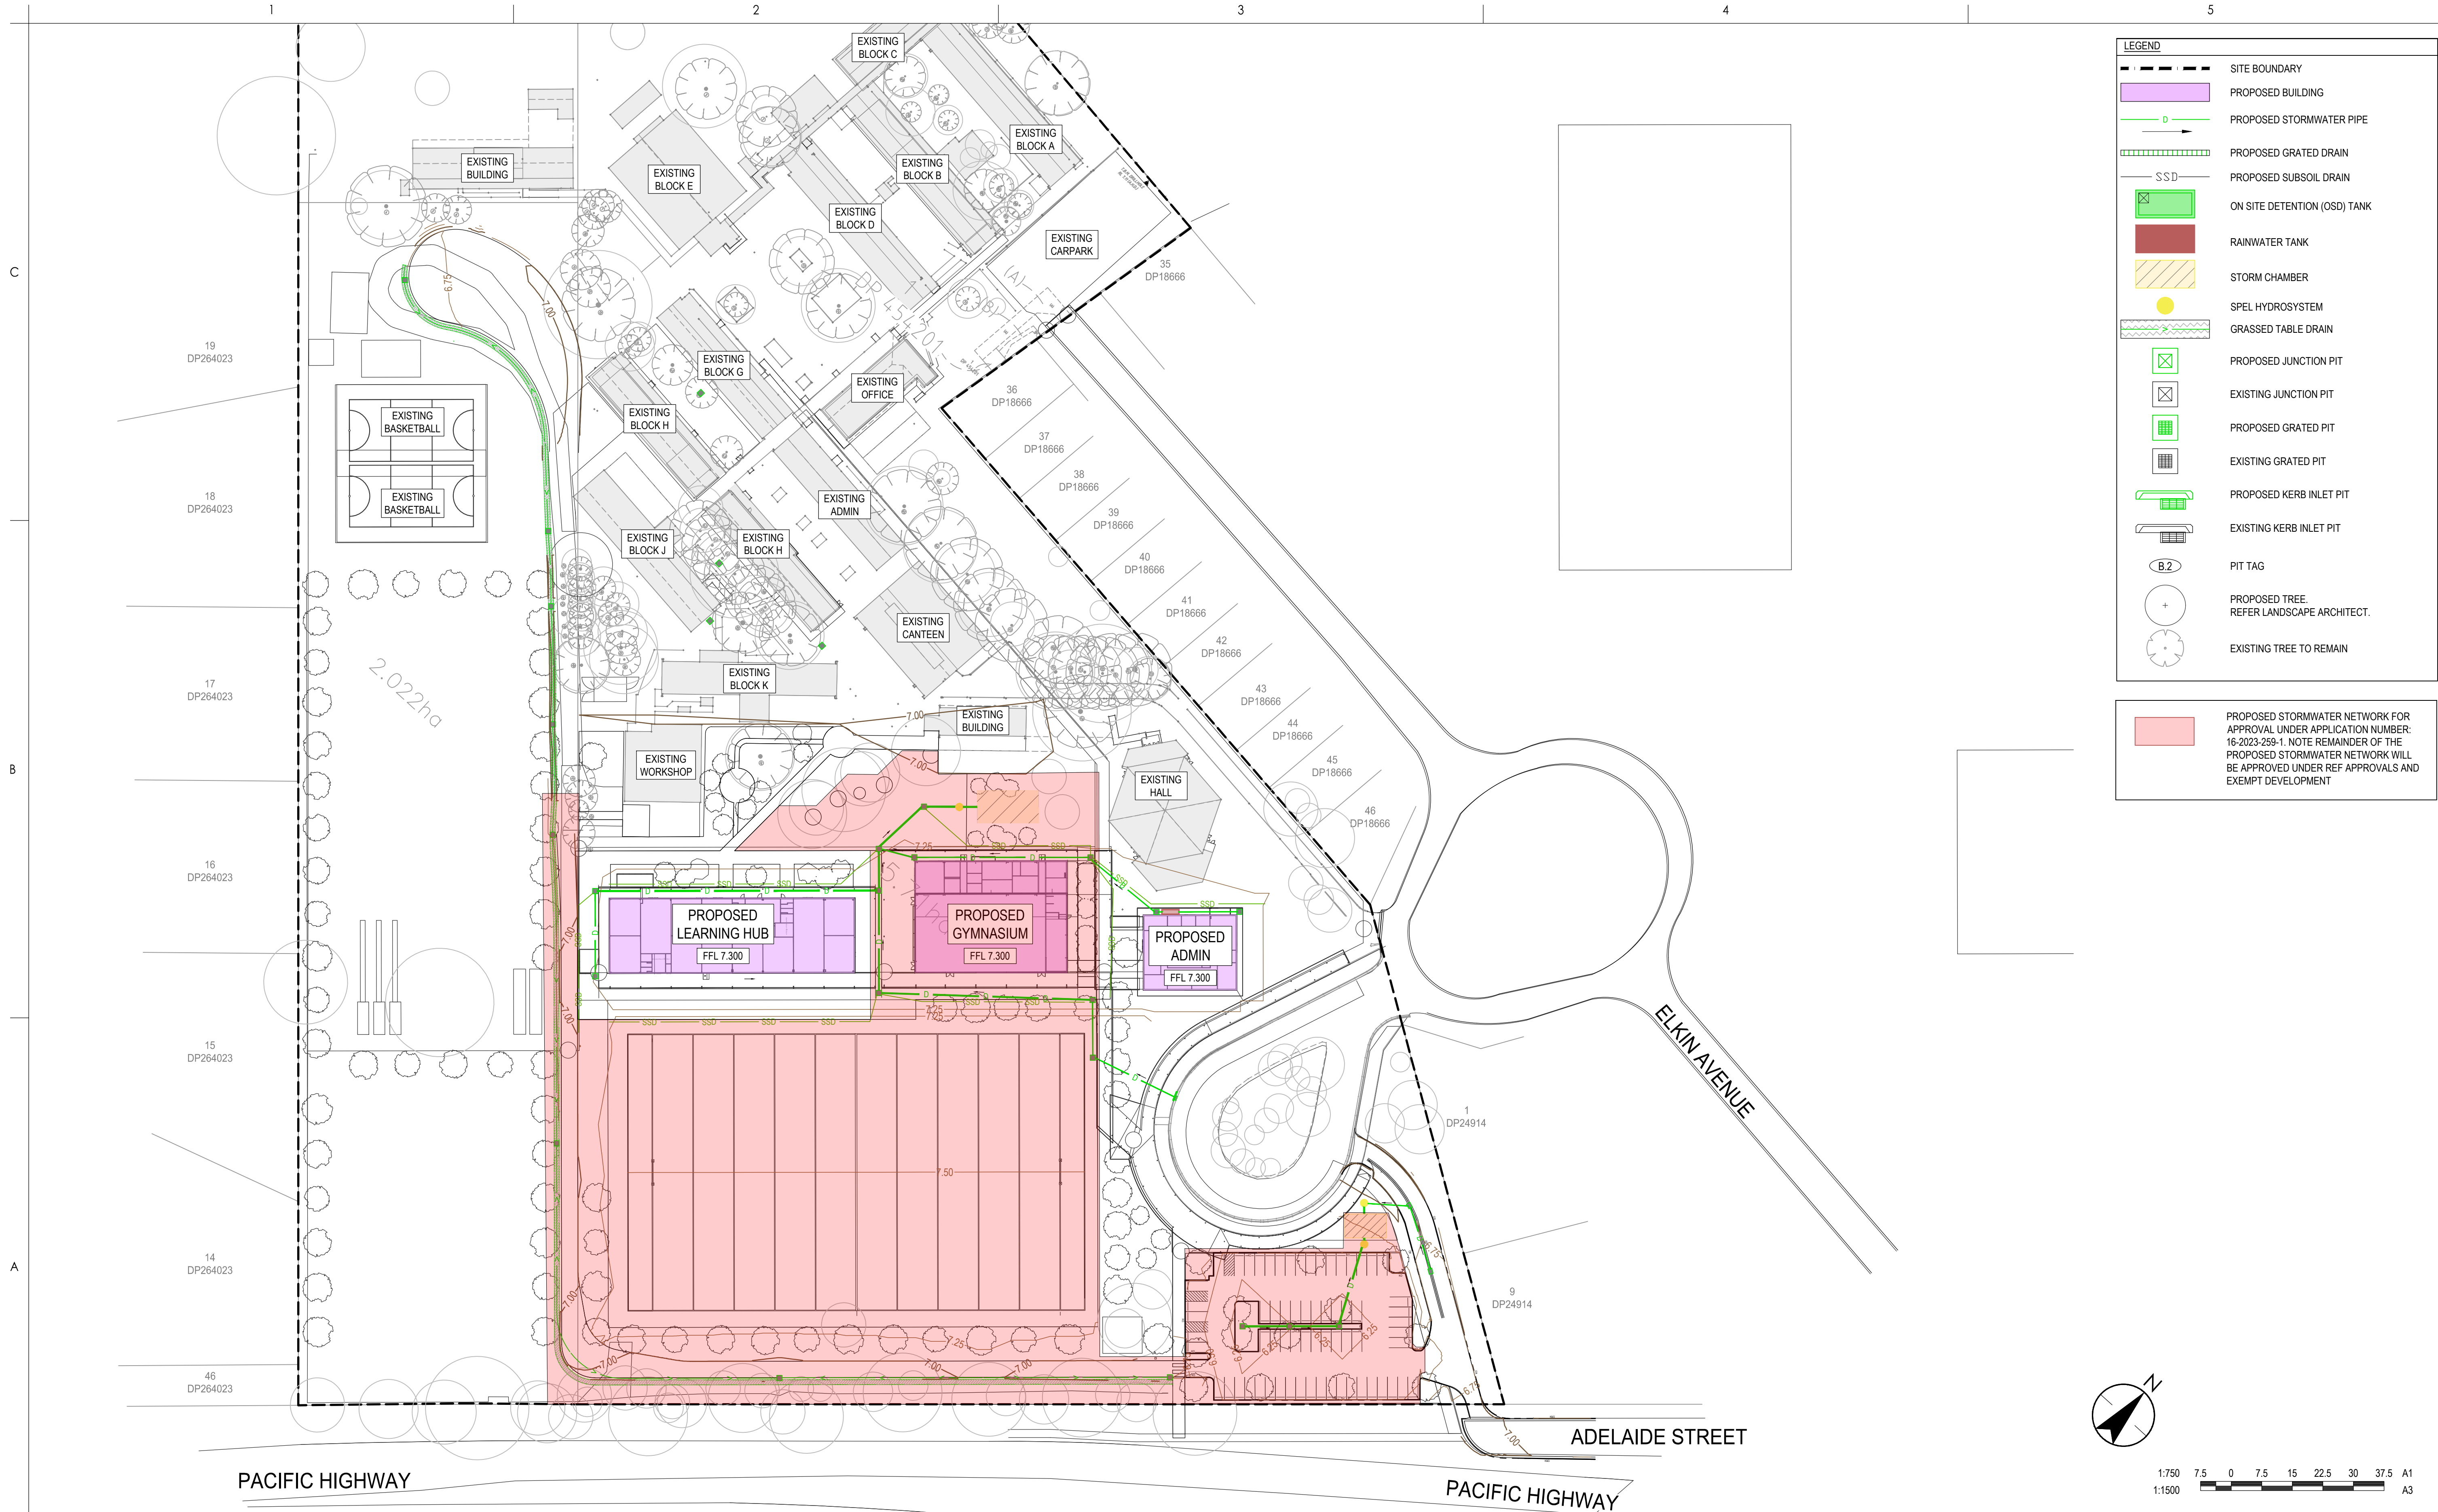

Notes

G	REVISED SCHEMATIC DESIGN	BCH	JMB	2023.09.01
F	REVISED SCHEMATIC DESIGN	LPT	JMB	2023.07.14
E	REVISED SCHEMATIC DESIGN	CPO	JMB	2023.04.13
D	DRAFT REVISED SCHEMATIC DESIGN ISSUE	CPO	JMB	2023.03.24
C	FINAL PHASE 3 ISSUE	CPO	JMB	2022.08.08
B	100% SCHEMATIC DESIGN PROCESS	CPO	JMB	2022.07.29
A	95% SCHEMATIC DESIGN PROCESS	CPO	JMB	2022.07.14

Issued/Revision

By

Appd

YYYY.MM.DD

Issue Status

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Client/Project Logo

Client/Project

SINSW

HUNTERS RIVER HIGH SCHOOL

HEATHERBRAE NSW 2324

File Name: HRHS-STNC-XX-XX-DR-C-520001.DWG

CPO

JMB

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2022.07.14

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YYYY.MM.DD

Title

STORMWATER DRAINAGE PLAN  
SITE WIDE

Project No.

Scale

1:750

Revision

D

Drawing No.

HRHS-STNC-XX-XX-DR-C-520001

Plotted: 01:56:23 24.07.28 PM By: HUNTER, BJA  
UN30130099 PROJECT DOCUMENTATION DRAWINGS & DESIGN VIEWS SHEET SET

ORIGINAL SHEET - ISO A1 COORD - MGA/YY Zone DATUM - mAHd












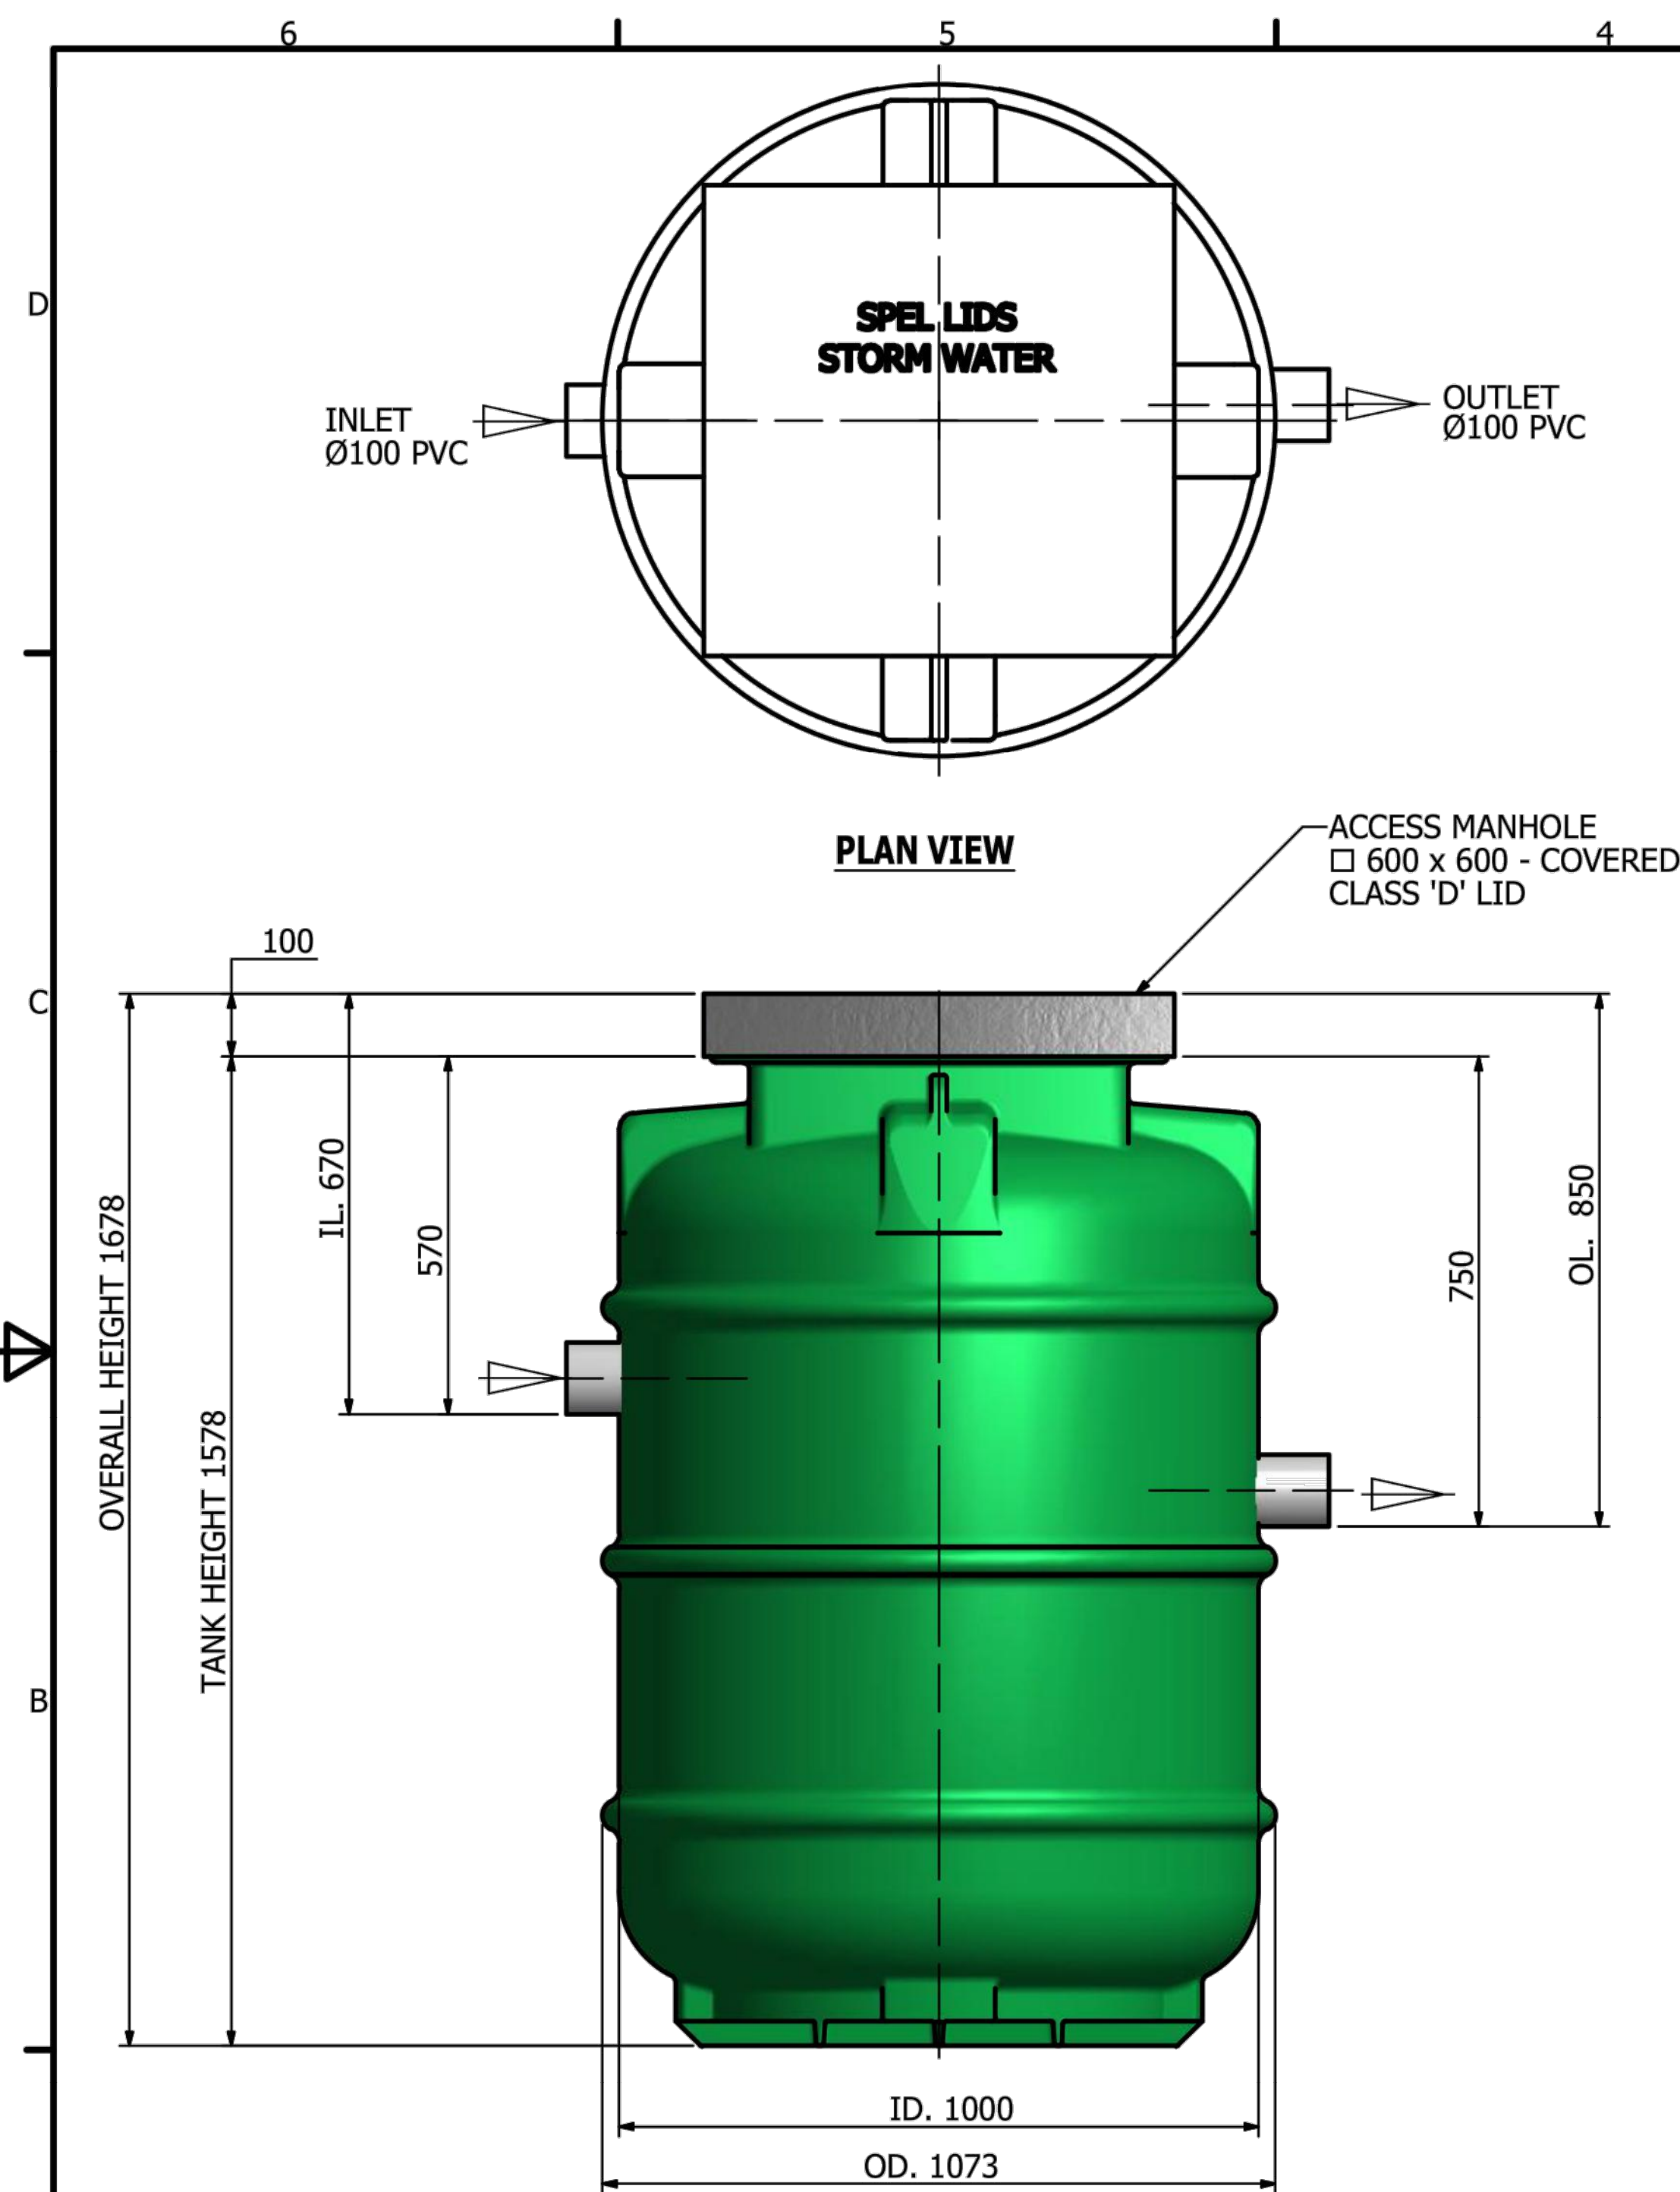

E	REVISED SCHEMATIC DESIGN	CPO	JMB 2023.04.13
D	DRAFT REVISED SCHEMATIC DESIGN ISSUE	CPO	JMB 2023.03.24
C	FINAL PHASE 3 ISSUE	CPO	JMB 2022.08.08
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A	95% SCHEMATIC DESIGN PROCESS	CPO	JMB 2022.07.14
<b>Issued/Revision</b>		<b>By</b>	<b>Appd</b> YYYY.MM.DD

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File Name: HRHS-STNC-XX-XX-DR-C-526001.DWG	CPO	JMB	JMB	2022.07.14
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Title

STORMWATER DRAINAGE DETAILS  
SHEET 3

Project No. \_\_\_\_\_

Scale  
NTS

Revision  
**F**

Drawing No.  
**HRHS-STNC-XX-XX-DR-C-526003**







